

320 N. Carrollton Avenue, Suite 100, New Orleans, Louisiana 70119 VergesRome.com t. 504.488.7739 f. 504.488.7743

December 1, 2011

VIA HAND DELIVERY

Ms. Leila Manouchehri New Orleans City Planning Commission City of New Orleans 1340 Poydras Street, Suite 900 New Orleans, Louisiana 70112

Re: Mid City Market VRA No. 11003

Dear Ms. Manouchehri:

Pursuant to our discussion, we are supplying the following information and revised documents for the design review of the referenced project. This project includes the following properties:

- 1. Square 538
- 2. Square 539A
- 3. Square 540, Lots A, B, C, D, W, X, Y, Z
- 4. Square 562, Lot C

Enclosed are the following items for the Design Review:

- 1. Letter to Edward J. Horan, City of New Orleans Zoning Administrator, dated 11.22.2011
- 2. Overall Site Plan Sheet A1, revised 12.22.2011
- 3. Property Boundaries Sheet A1.1
- 4. Exterior Elevations Sheet A2.0, revised 11.29.2011
- 5. Exterior Elevations Sheet A2.1, revised 11.29.2011
- 6. Exterior Elevations Sheet A2.2
- 7. Exterior Elevations Sheet A2.3, revised 11.29.2011
- 8. Exterior Elevations Sheet A2.4, revised 11.29.2011
- 9. Overall Landscape Plan Sheet L1, revised 11.28.2011
- 10. Materials List Notes and Details Sheet L2, revised 11.29.2011
- 11. Site Lighting Plan Sheet E0.02, dated 11.29.2011
- 12. Site Lighting Fixture Cut Sheets

We have included one full size and one half size set of the drawings indicated above. If you need any additional copies or have any questions, please call our office.

Sincerely,

VergesRome Architects, APAG

Ernest E. Verges, II, A

EEV/tmb Enclosures

cc: Mr. Townsend Underhill w/o enclosures (via email tunderhill@stirlingprop.com)

Office File

Ernest E. (Chip) Verges, II, AIA Steven H. Rome, AIA Ernest E. Verges, AIA-E John F. Morton, Jr., AIA Richard W. Fenner, AIA David Glen Reed, AIA Michael J. Roussel, AIA Stephanie C. Parent, AIA Anthony J. Taffaro, AIA



320 N. Carrollton Avenue, Suite 100, New Orleans, Louisiana 70119 VergesRome.com t. 504.488.7739 f. 504.488.7743

22 November 2011

VIA HAND DELIVERY

Mr. Edward J. Horan
City of New Orleans
Zoning Administrator
1300 Perdido Street, Room 7E05
New Orleans, Louisiana 70112

Re: Mid City Market

Carrollton Avenue and Bienville Avenue

New Orleans, Louisiana VRA Project No. 11003

Dear Ed:

This letter is to confirm the meeting Michael Roussel and I had with you and Jared Munster today, wherein we discussed the zoning requirements for the Mid City Market project referenced above. We discussed the following items and reviewed the VergesRome Architects drawing dated 22 November 2011:

- The location of the buildings on the large site, which includes the Winn Dixie on the rear of the site and the two smaller retail buildings located on Carrollton Avenue, meet Inner-City Urban Corridor District and Big Box requirements. This includes building setbacks.
- The parking for the site will meet the required parking as indicated on the Site Data on the drawings. Parking is included on the two main sites and two remote sites adjacent to the property.
- The site at the corner of Carrollton and Bienville will retain the existing building and a new building will be built at the corner of the site.
- 4. Landscaping will be included on the site per Inner-City Urban Corridor and Big Box requirements.
- The configuration of the enclosed loading area at the rear of the Winn Dixie meets the Inner-City Urban Corridor requirements. The 20' setback is not required because the loading area is enclosed.

Please sign below confirming your conceptual approval of our discussion, as outlined above, and the attached drawing dated 22 November 2011. Thanks for your help with this project.


Sincerely,

VergesRome Architects, APAC

Ernest E. Verges, II, A

EEV/tmb Attachment cc: Office File City of New Orleans – Safety and Permits

Edward J. Horan, Zoning Administrator

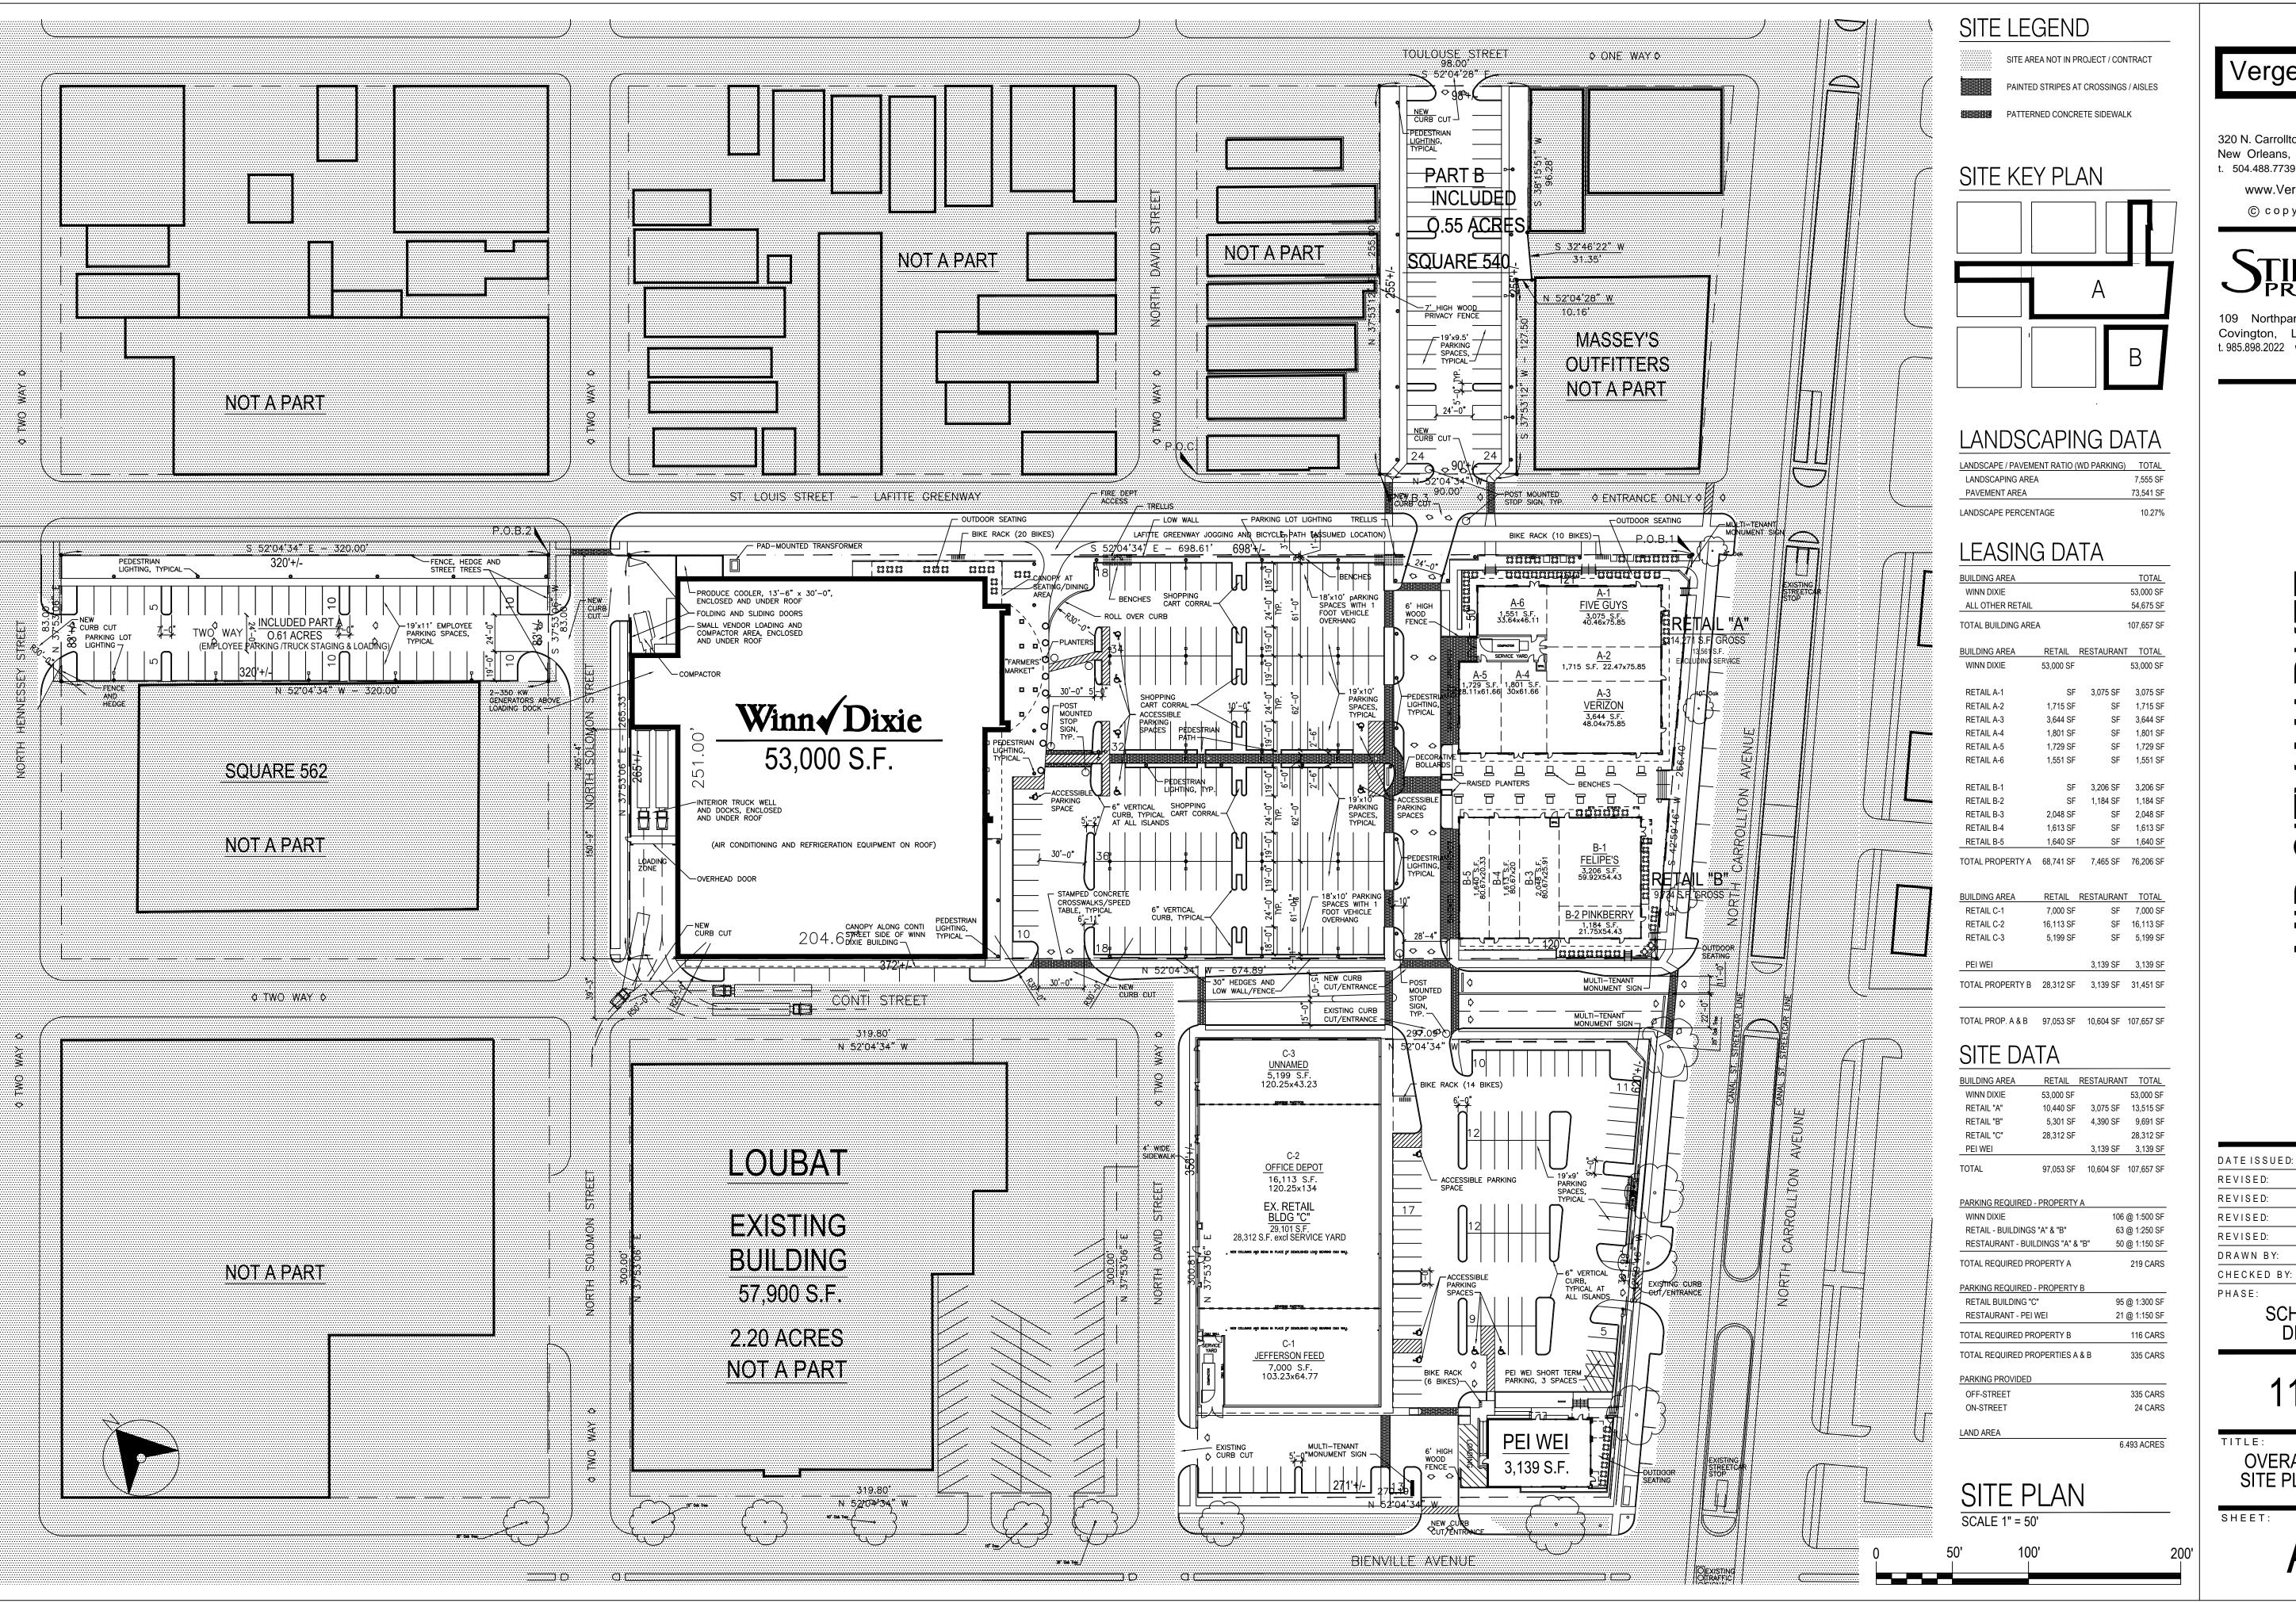

320 N. Carrollton Avenue, Suite 100 New Orleans, Louisiana 70119 t. 504.488.7739 f. 504.488.7743

Architects

www.VergesRome.com © copyright 2011

PROPERTIES

109 Northpark Blvd., Suite 300 Covington, Louisiana 70433 t. 985.898.2022 www.stirlingproperties.com

OVERALL SITE PLAN SHEET:

TITLE:

A1

SCHEMATIC


DESIGN

11003

26 OCTOBER 2011

17 NOVEMBER 2011

22 NOVEMBER 2011

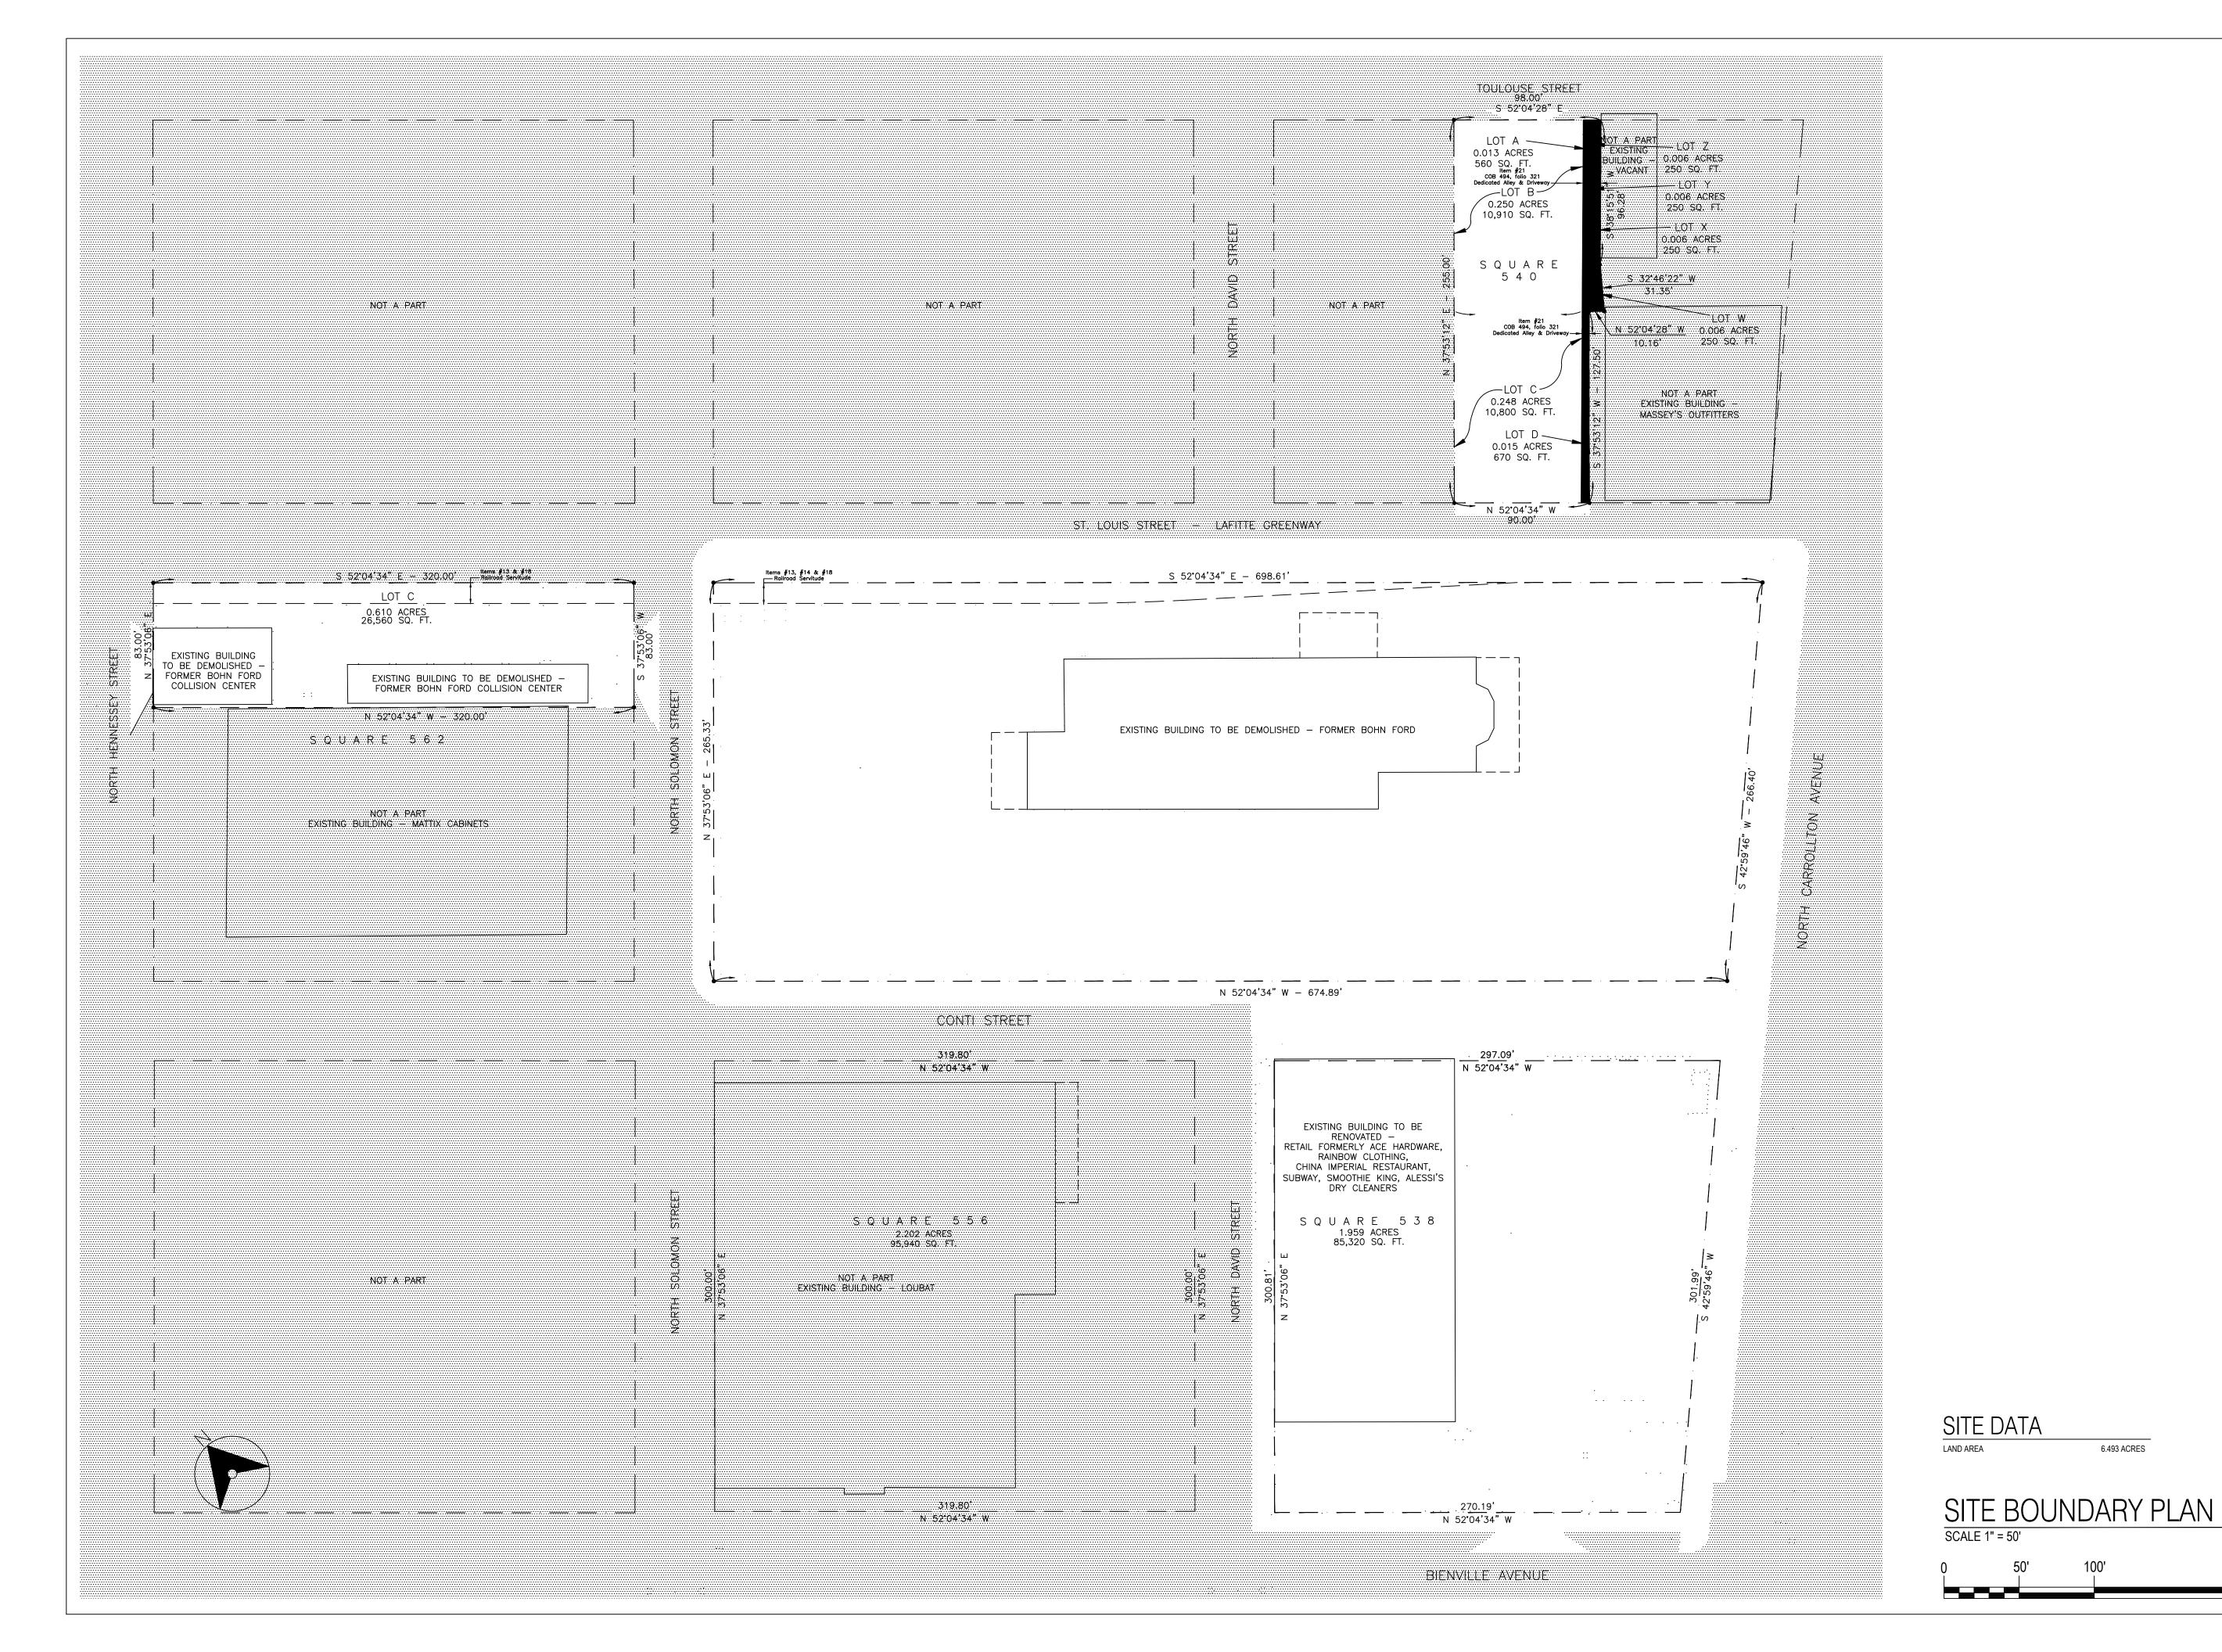



320 N. Carrollton Avenue, Suite 100 New Orleans, Louisiana 70119 t. 504.488.7739 f. 504.488.7743

> www.VergesRome.com © copyright 2011

109 Northpark Blvd., Suite 300 Covington, Louisiana 7 0 4 3 3 t. 985.898.2022 www.stirlingproperties.com



DATEISSUED: 14 OCTOBER 2011 REVISED: REVISED: REVISED: REVISED: DRAWN BY: CHECKED BY: PHASE:

CITY PLANNING COMMISSION

11003


TITLE:

6.493 ACRES

PROPERTY BOUNDARIES

SHEET:

A1.1

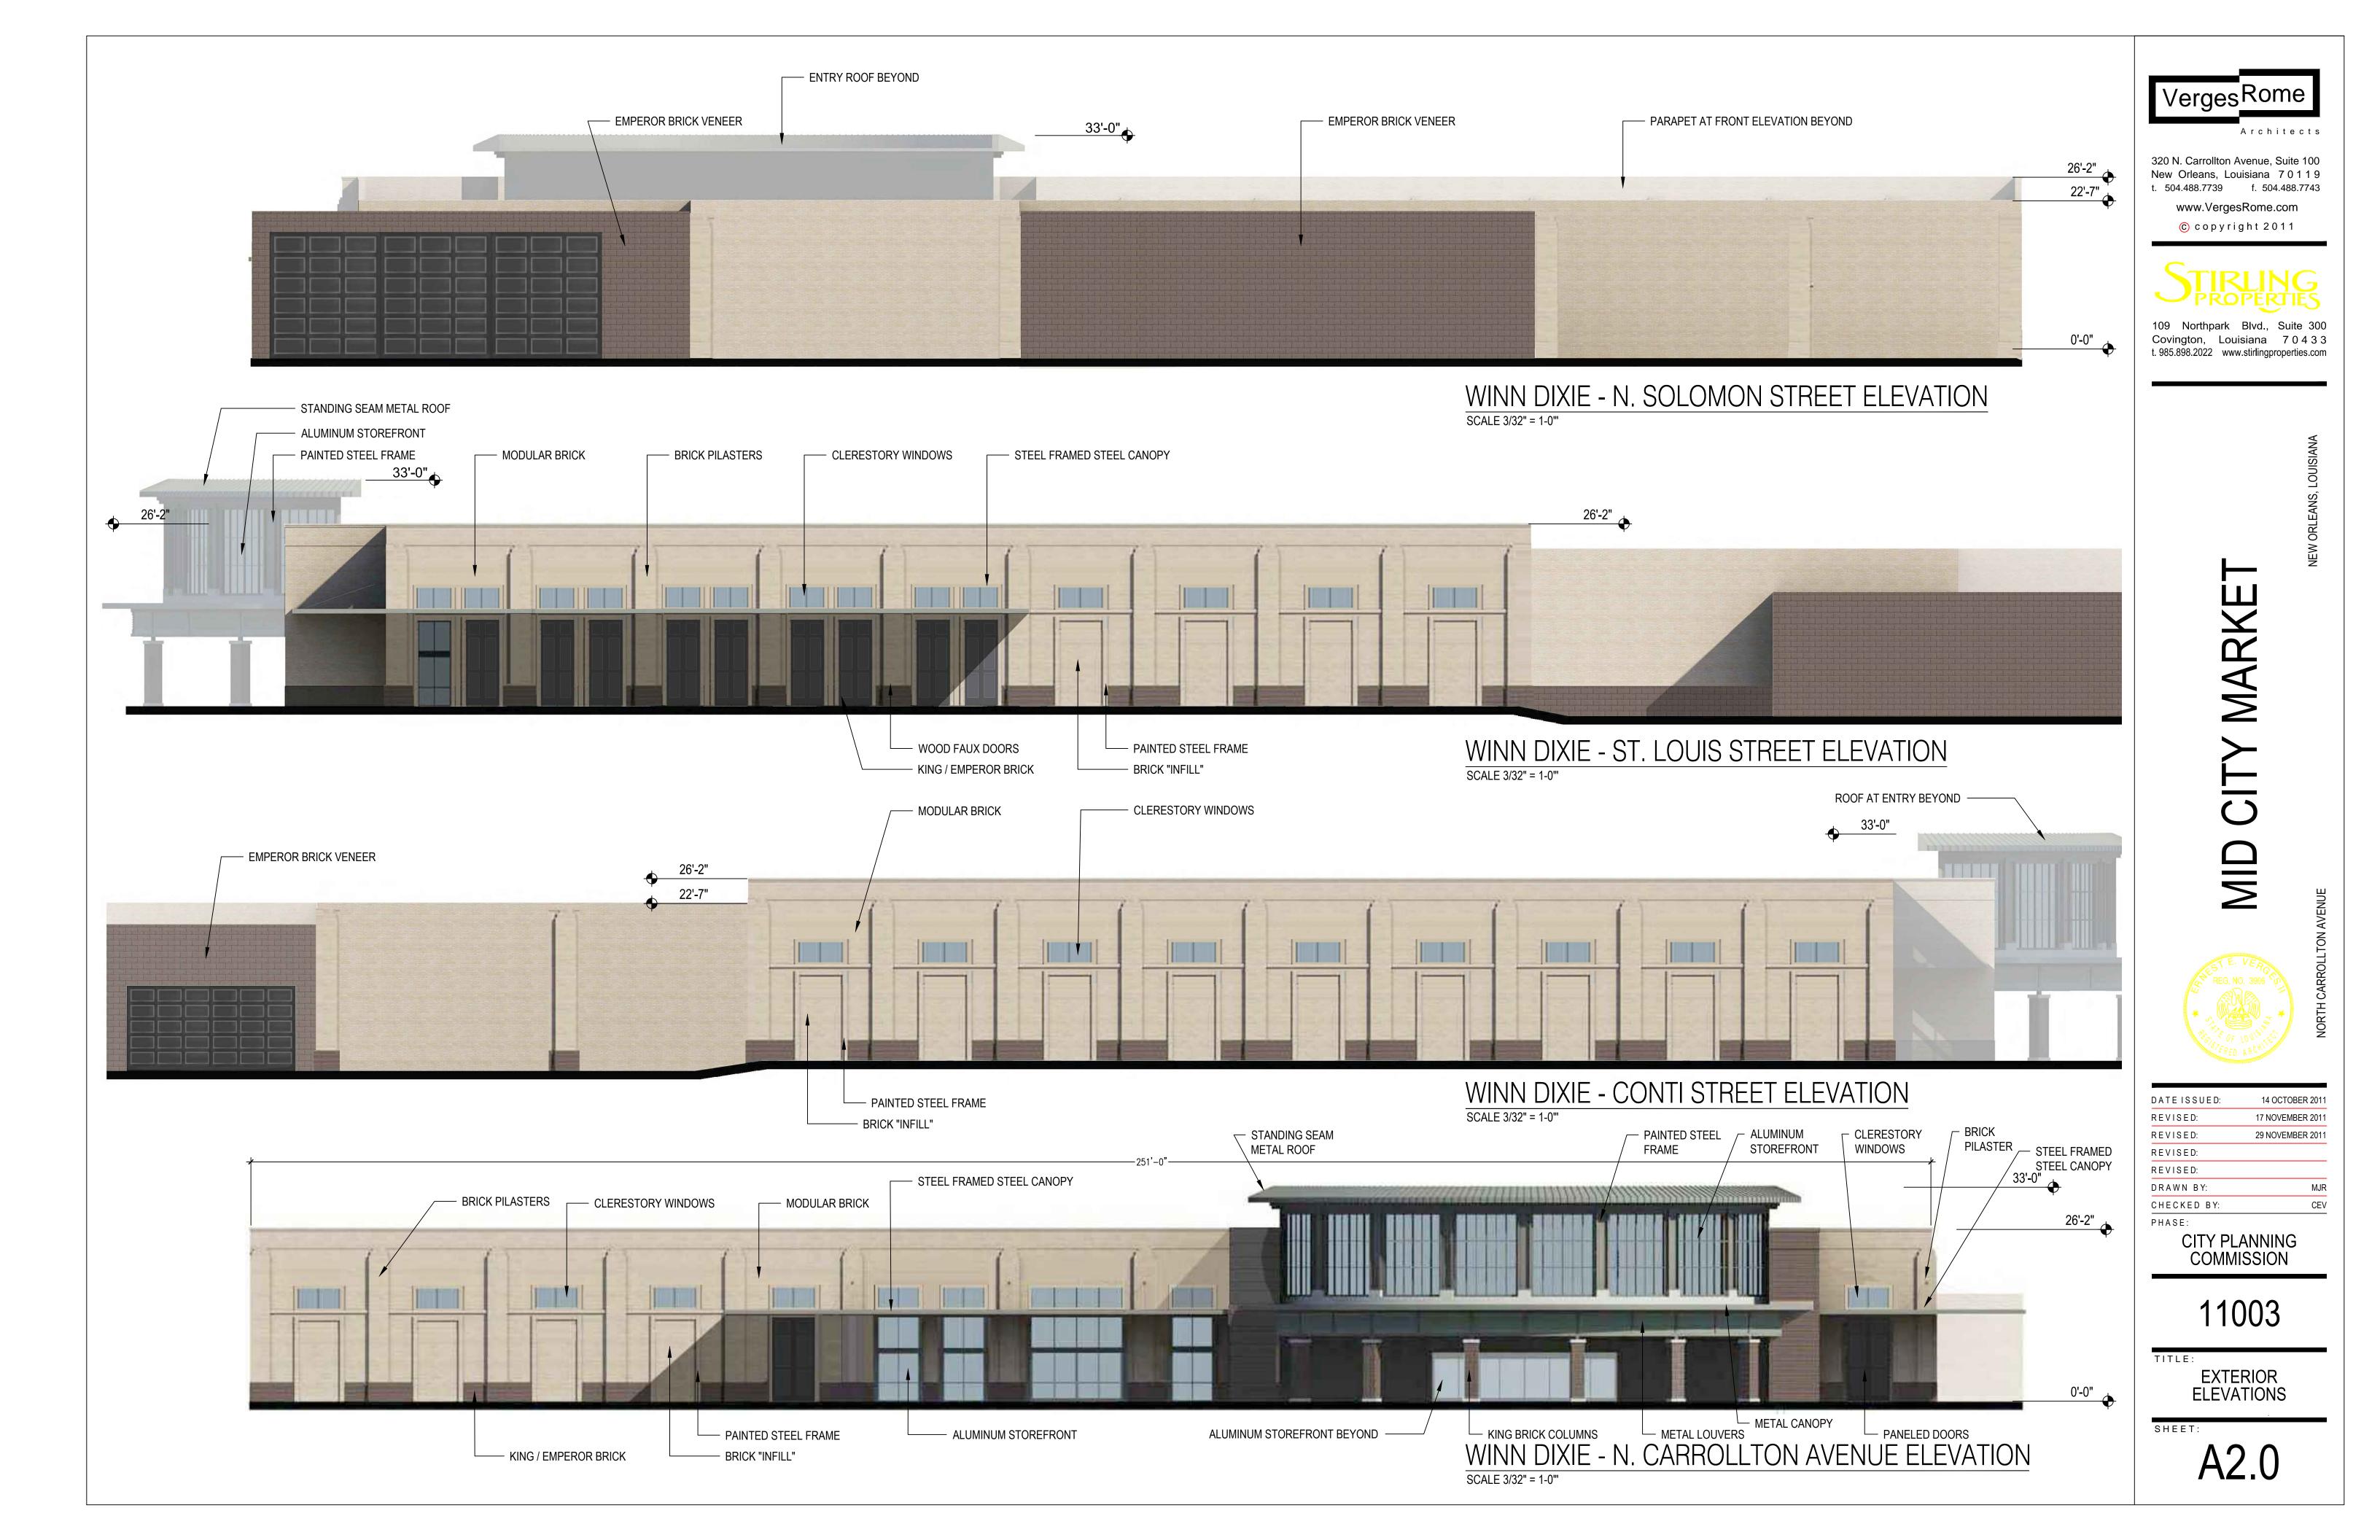



Verges Rome

Architects

320 N. Carrollton Avenue, Suite 100 New Orleans, Louisiana 70119 t. 504.488.7739 f. 504.488.7743

> www.VergesRome.com © copyright 2011

109 Northpark Blvd., Suite 300 Covington, Louisiana 70433 t. 985.898.2022 www.stirlingproperties.com

 \geq



DATE ISSUED:	14 OCTOBER 2011
REVISED:	17 NOVEMBER 2011
REVISED:	29 NOVEMBER 2011
REVISED:	
REVISED:	
DRAWN BY:	MJR
CHECKED BY:	CEV

CITY PLANNING COMMISSION

11003

TITLE:

EXTERIOR ELEVATIONS

SHEET:





320 N. Carrollton Avenue, Suite 100 New Orleans, Louisiana 7 0 1 1 9 t. 504.488.7739 f. 504.488.7743

www.VergesRome.com
© copyright 2011

STIRLING

109 Northpark Blvd., Suite 300 Covington, Louisiana 7 0 4 3 3 t. 985.898.2022 www.stirlingproperties.com

N ORLEANS, LOUISIAN

ID CITY MARKET



DATE ISSUED:	14 OCTOBER 2011
REVISED:	
REVISED:	
REVISED:	
REVISED:	
DRAWN BY:	MJR
CHECKED BY:	CEV
PHASE:	


CITY PLANNING COMMISSION

11003

TITLE:

EXTERIOR ELEVATIONS

SHEET:

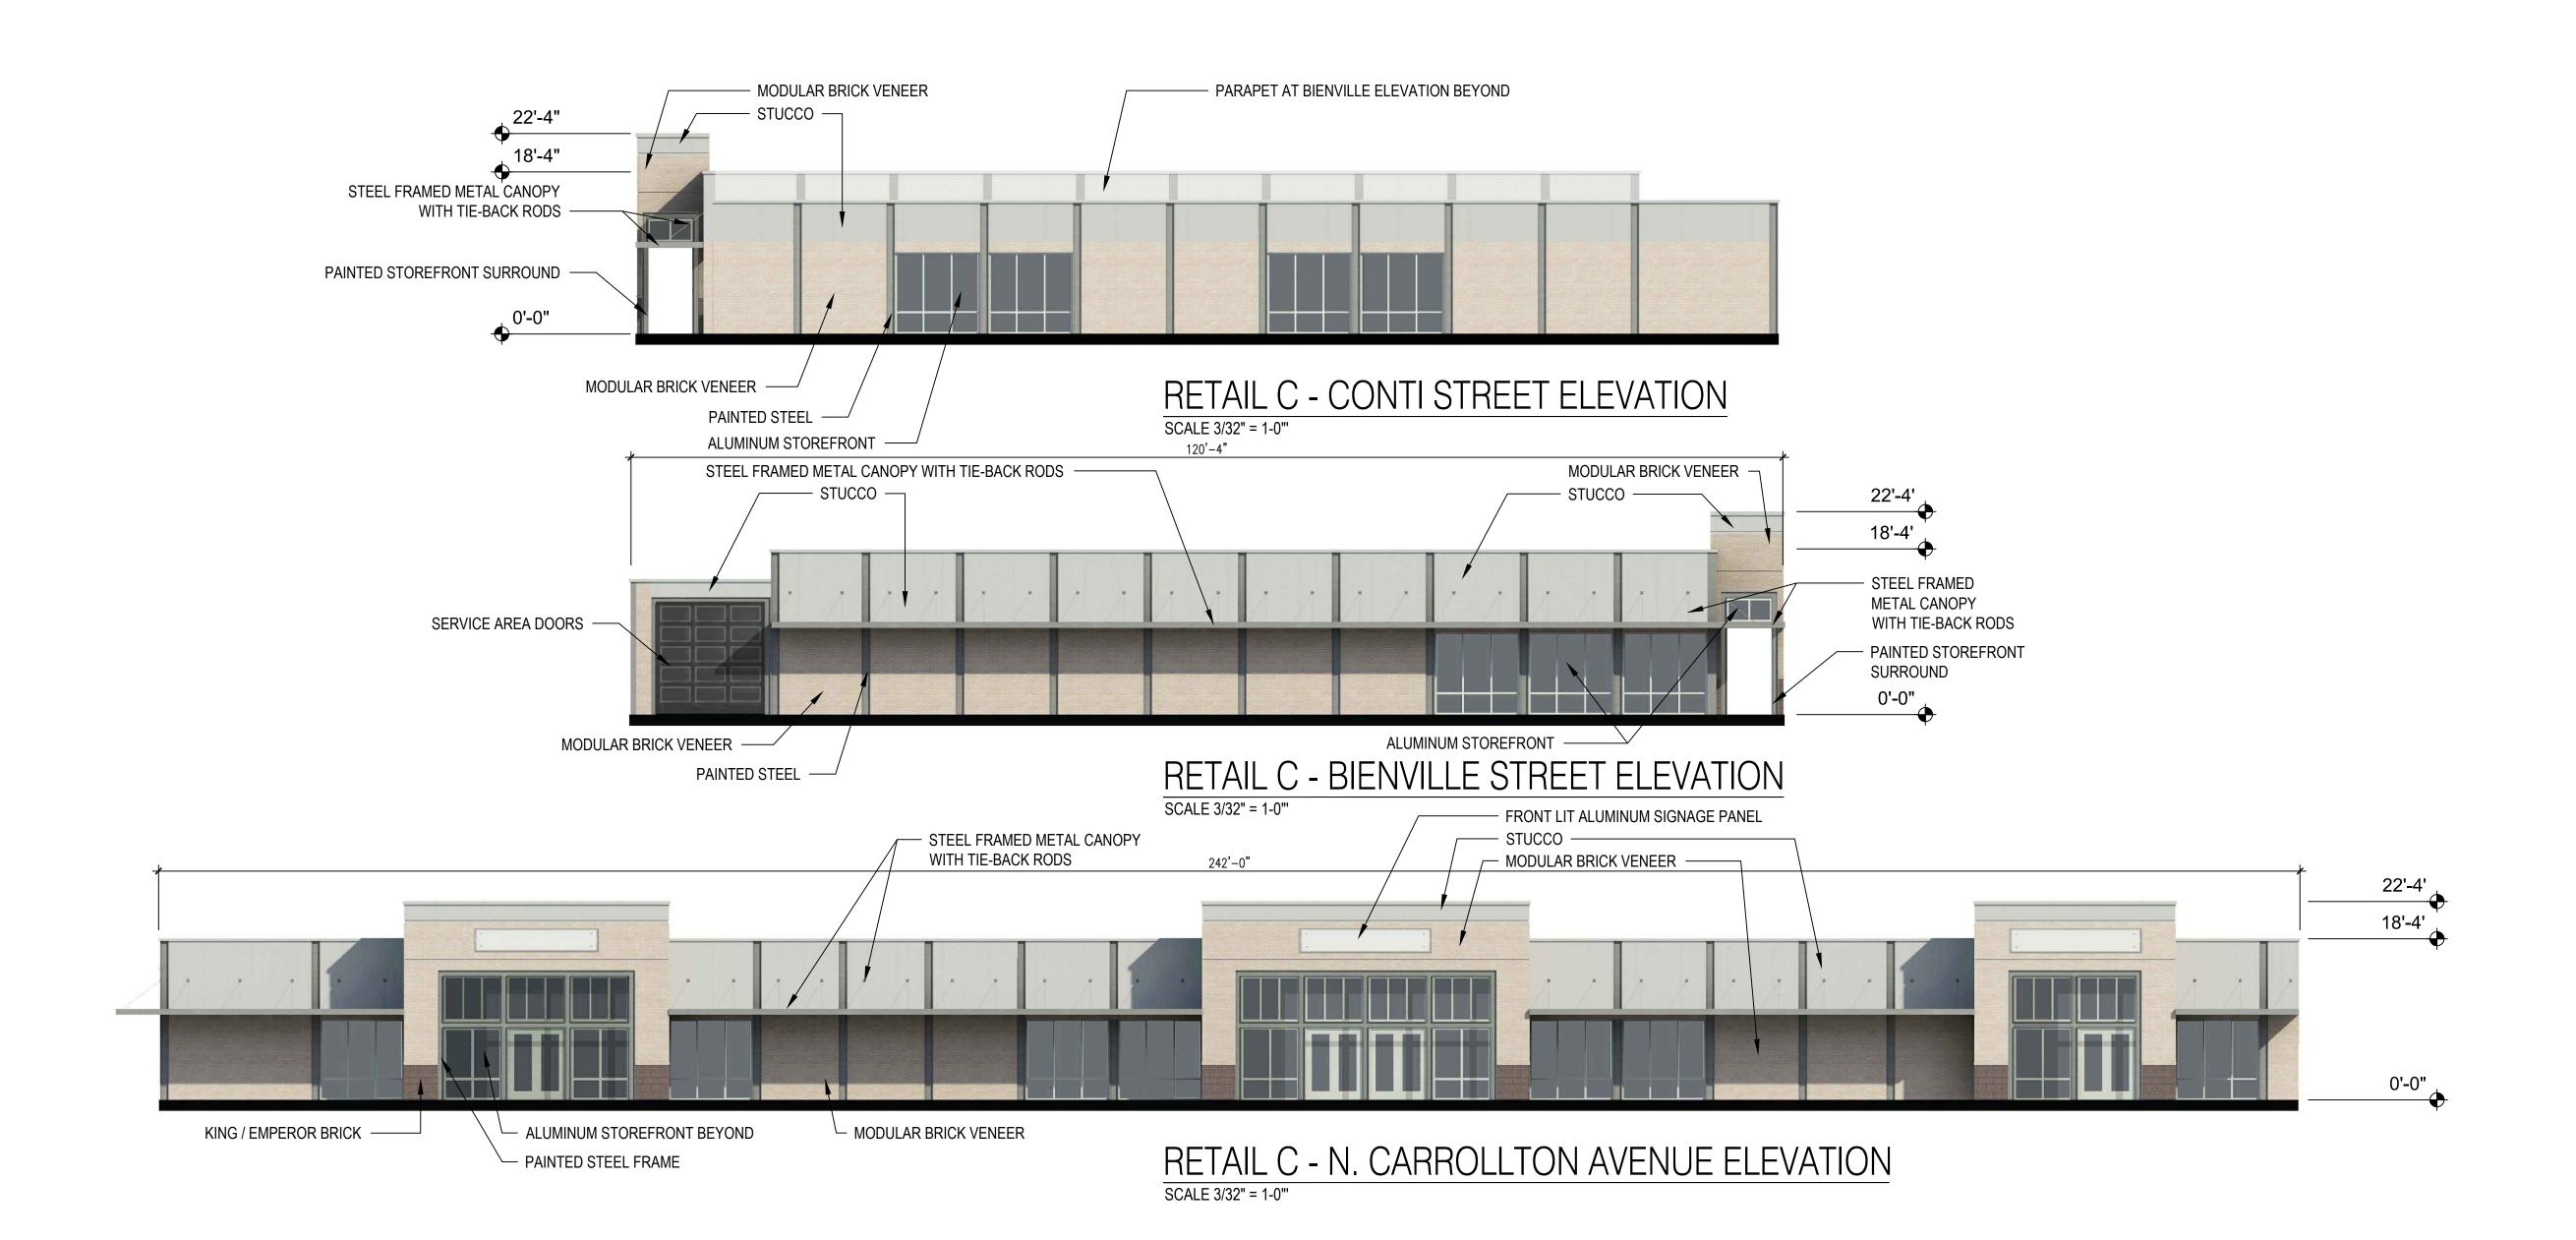



Architec

320 N. Carrollton Avenue, Suite 100 New Orleans, Louisiana 7 0 1 1 9 t. 504.488.7739 f. 504.488.7743

www.VergesRome.com
© copyright 2011

STIRLING PROPERTIES

109 Northpark Blvd., Suite 300 Covington, Louisiana 7 0 4 3 3 t. 985.898.2022 www.stirlingproperties.com

W ORLEANS, LOUISIAN

MAKALI

REG. NO. 3906 TO



DATE ISSUED:	14 OCTOBER 201
REVISED:	17 NOVEMBER 2011
R E V I S E D:	
R E V I S E D:	
R E V I S E D:	
DRAWN BY:	MJF
CHECKED BY:	CE\
PHASE:	


CITY PLANNING COMMISSION

11003

TITLE:

EXTERIOR ELEVATIONS

SHEET:

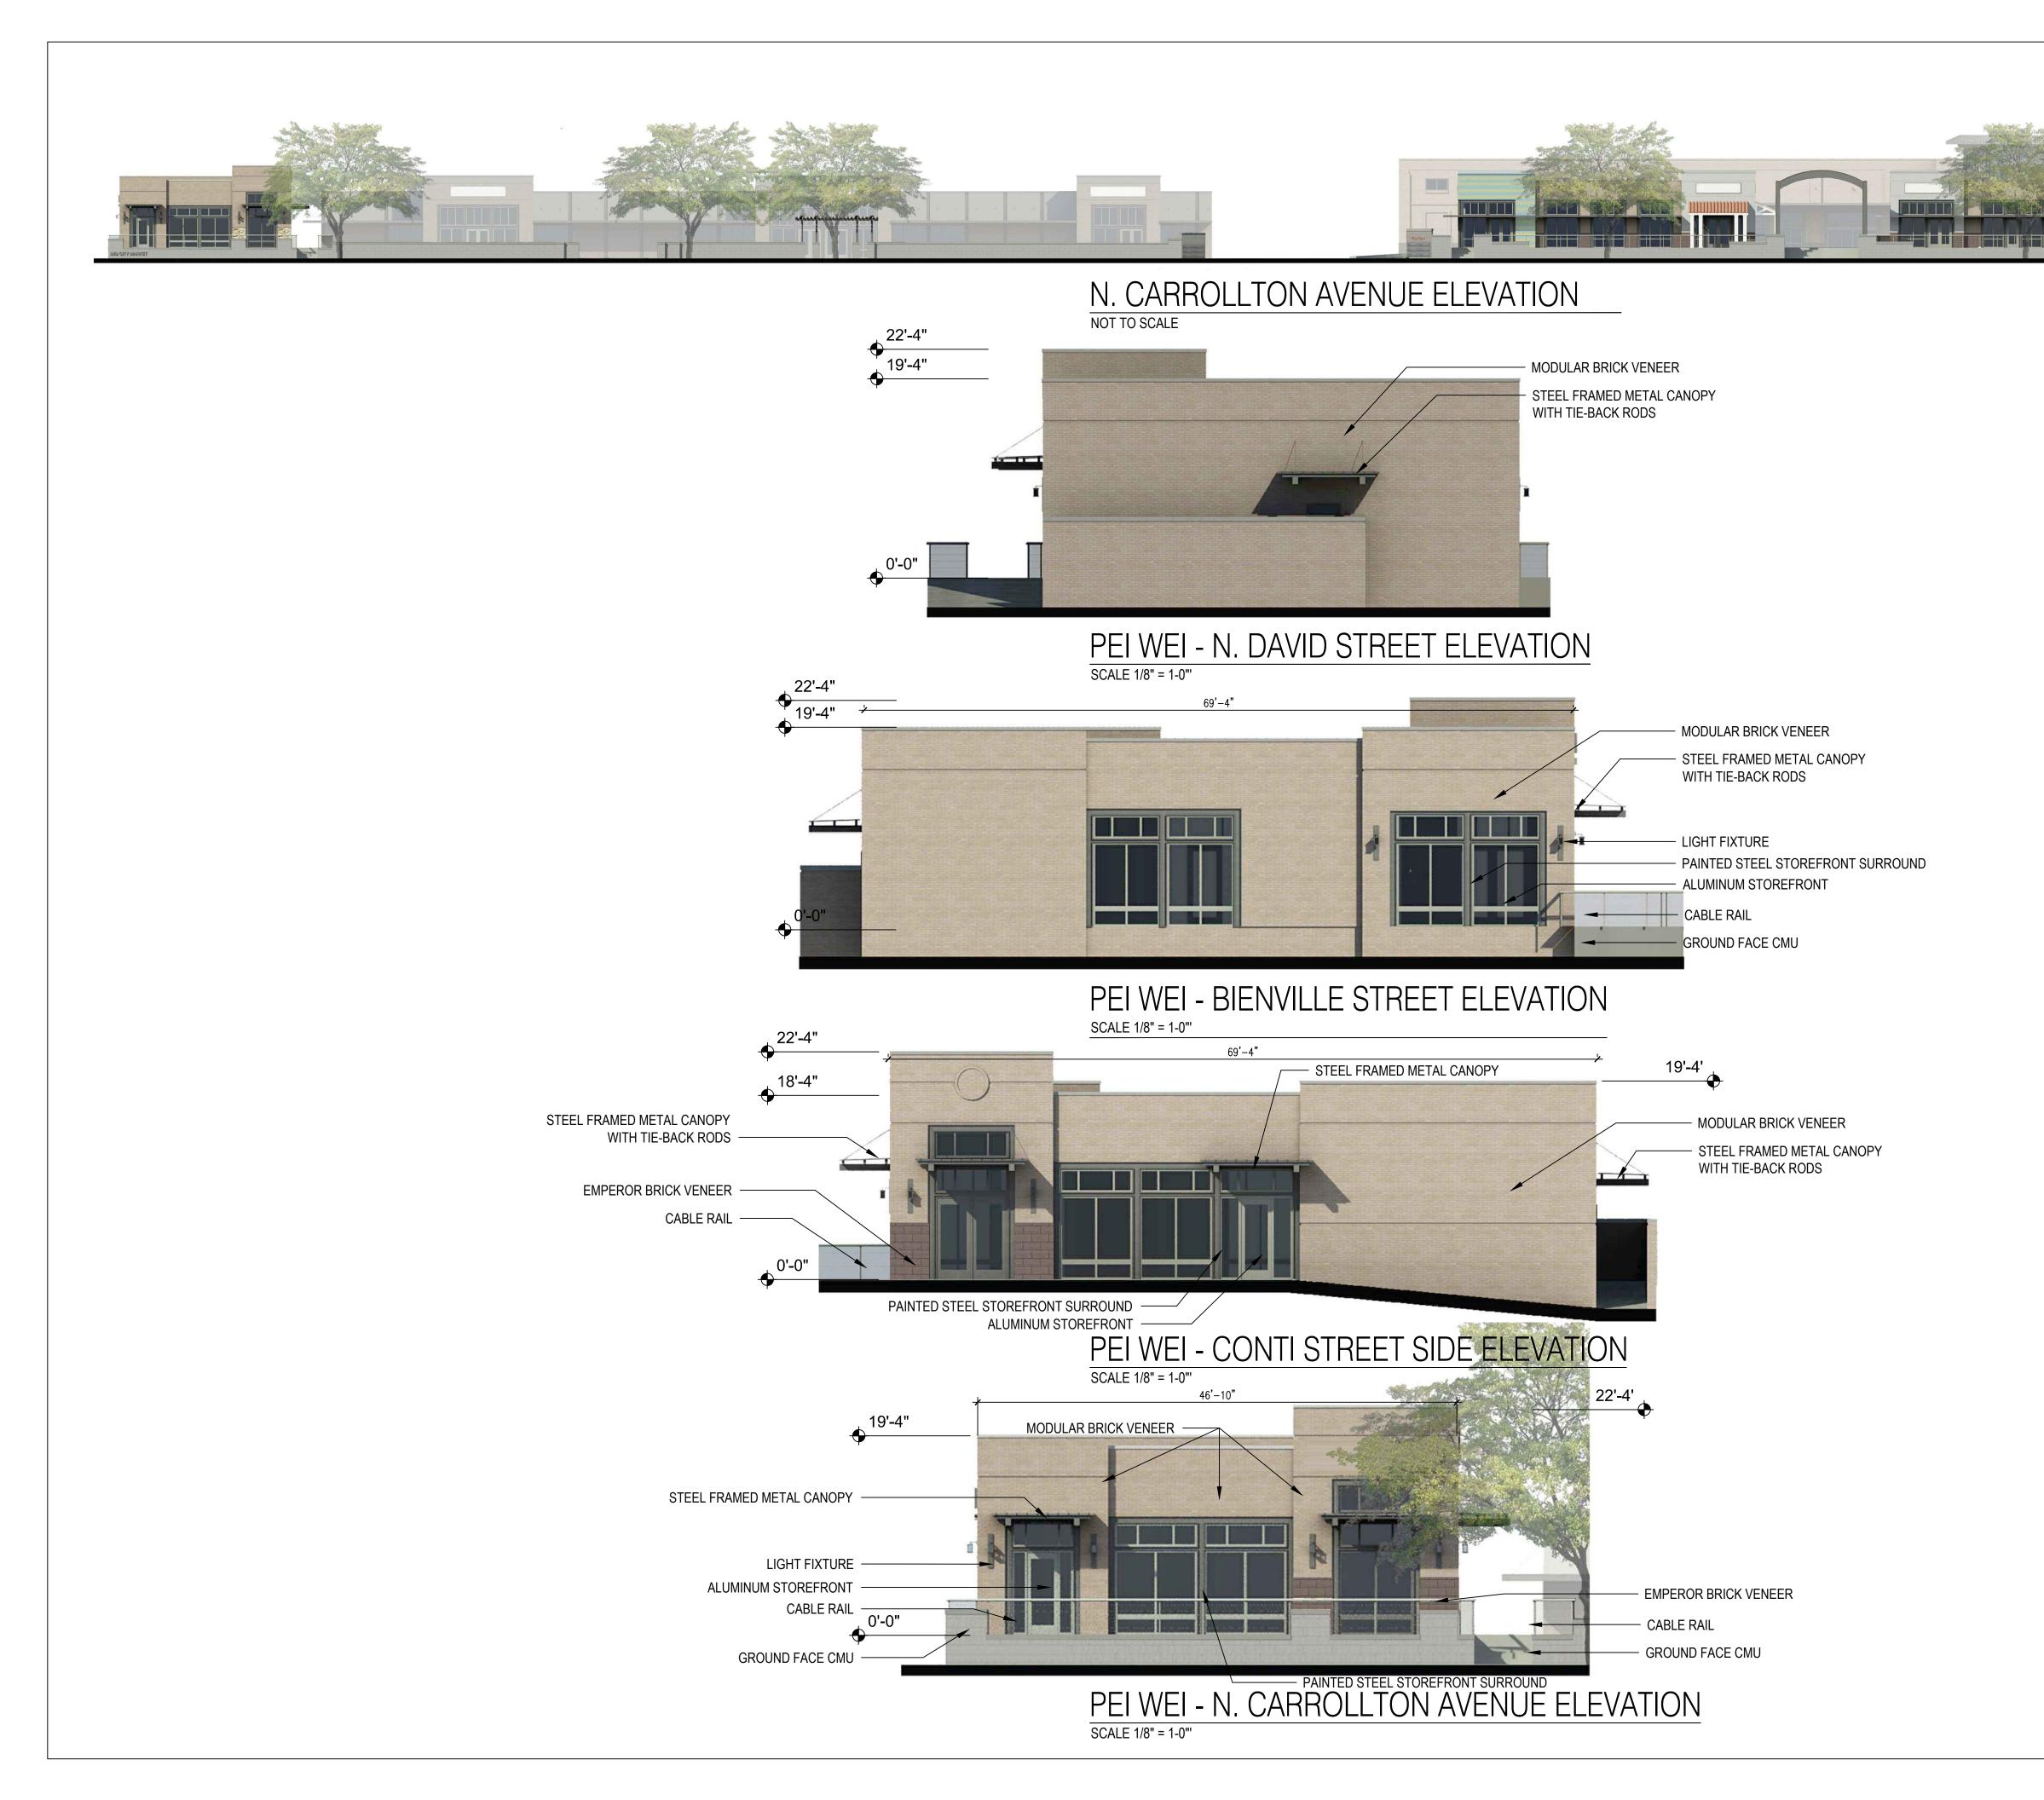



320 N. Carrollton Avenue, Suite 100 New Orleans, Louisiana 7 0 1 1 9 t. 504.488.7739 f. 504.488.7743

www.VergesRome.com
© copyright 2011

STIRLING PROPERTIES

109 Northpark Blvd., Suite 300 Covington, Louisiana 7 0 4 3 3 t. 985.898.2022 www.stirlingproperties.com

N ORLEANS, LOUISIA

CITY MARKET



DATEISSUED:	14 OCTOBER 2011
REVISED:	17 NOVEMBER 2011
REVISED:	29 NOVEMBER 2011
REVISED:	
REVISED:	
DRAWN BY:	MJR
CHECKED BY:	CEV
PHASE.	


CITY PLANNING COMMISSION

11003

TITLE:

EXTERIOR ELEVATIONS

SHEET:

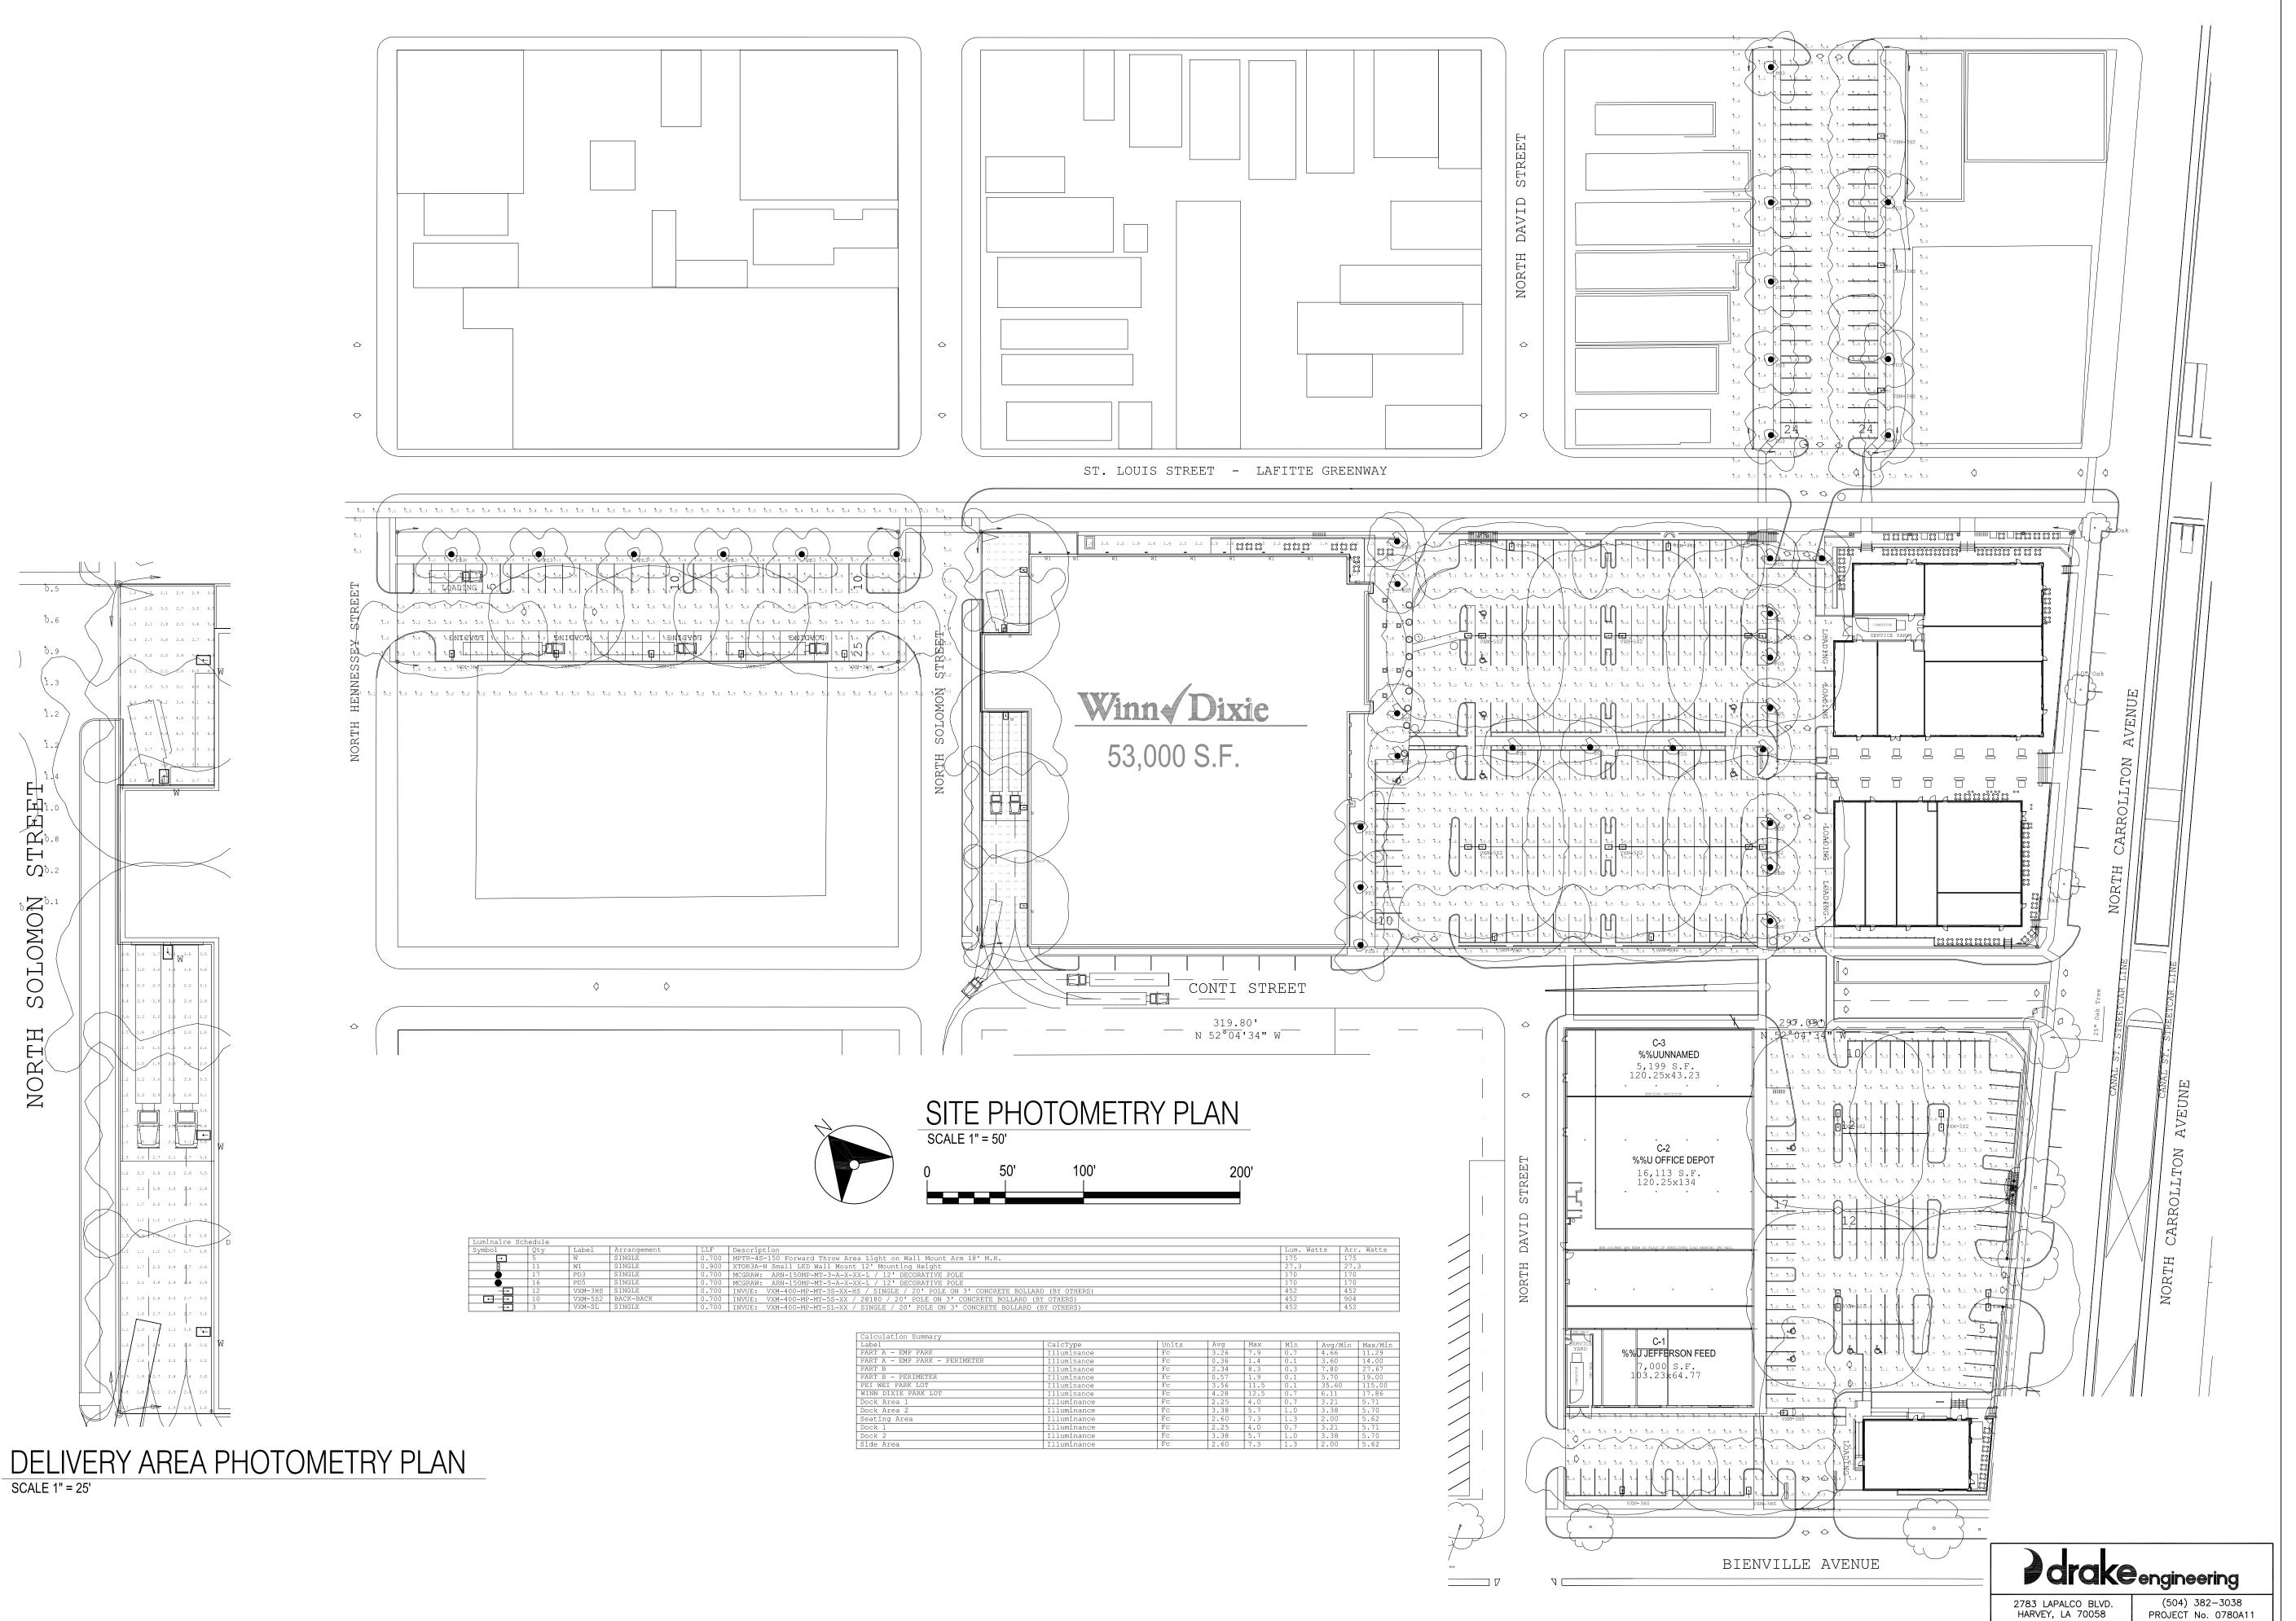

VergesRome

320 N. Carrollton Avenue, Suite 100 New Orleans, Louisiana 7 0 1 1 9 t. 504.488.7739 f. 504.488.7743

Architects

www.VergesRome.com
© copyright 2011

NOTE TO BE USED FOR CONSTRUCTION, BIDDING, RECORDATION, CONVEYANCE, SALES, OR AS THE BASIS FOR THE ISSUANCE OF A PERMIT. RYAN C. ORGERON LICENSE # 29405

RLEANS, LOUISIANA

CITY MARKET


STH CARROLLTON AVENIL

DATE ISSUED:	S U E D: 29 NOVEMBER 2011		
REVISED:			
DRAWN BY:	JNW		
CHECKED BY:	RCO		
PHASE:			
SCHEMATIC DESIGN			

11003

SITE PHOTOMETRY PLAN

E0.02

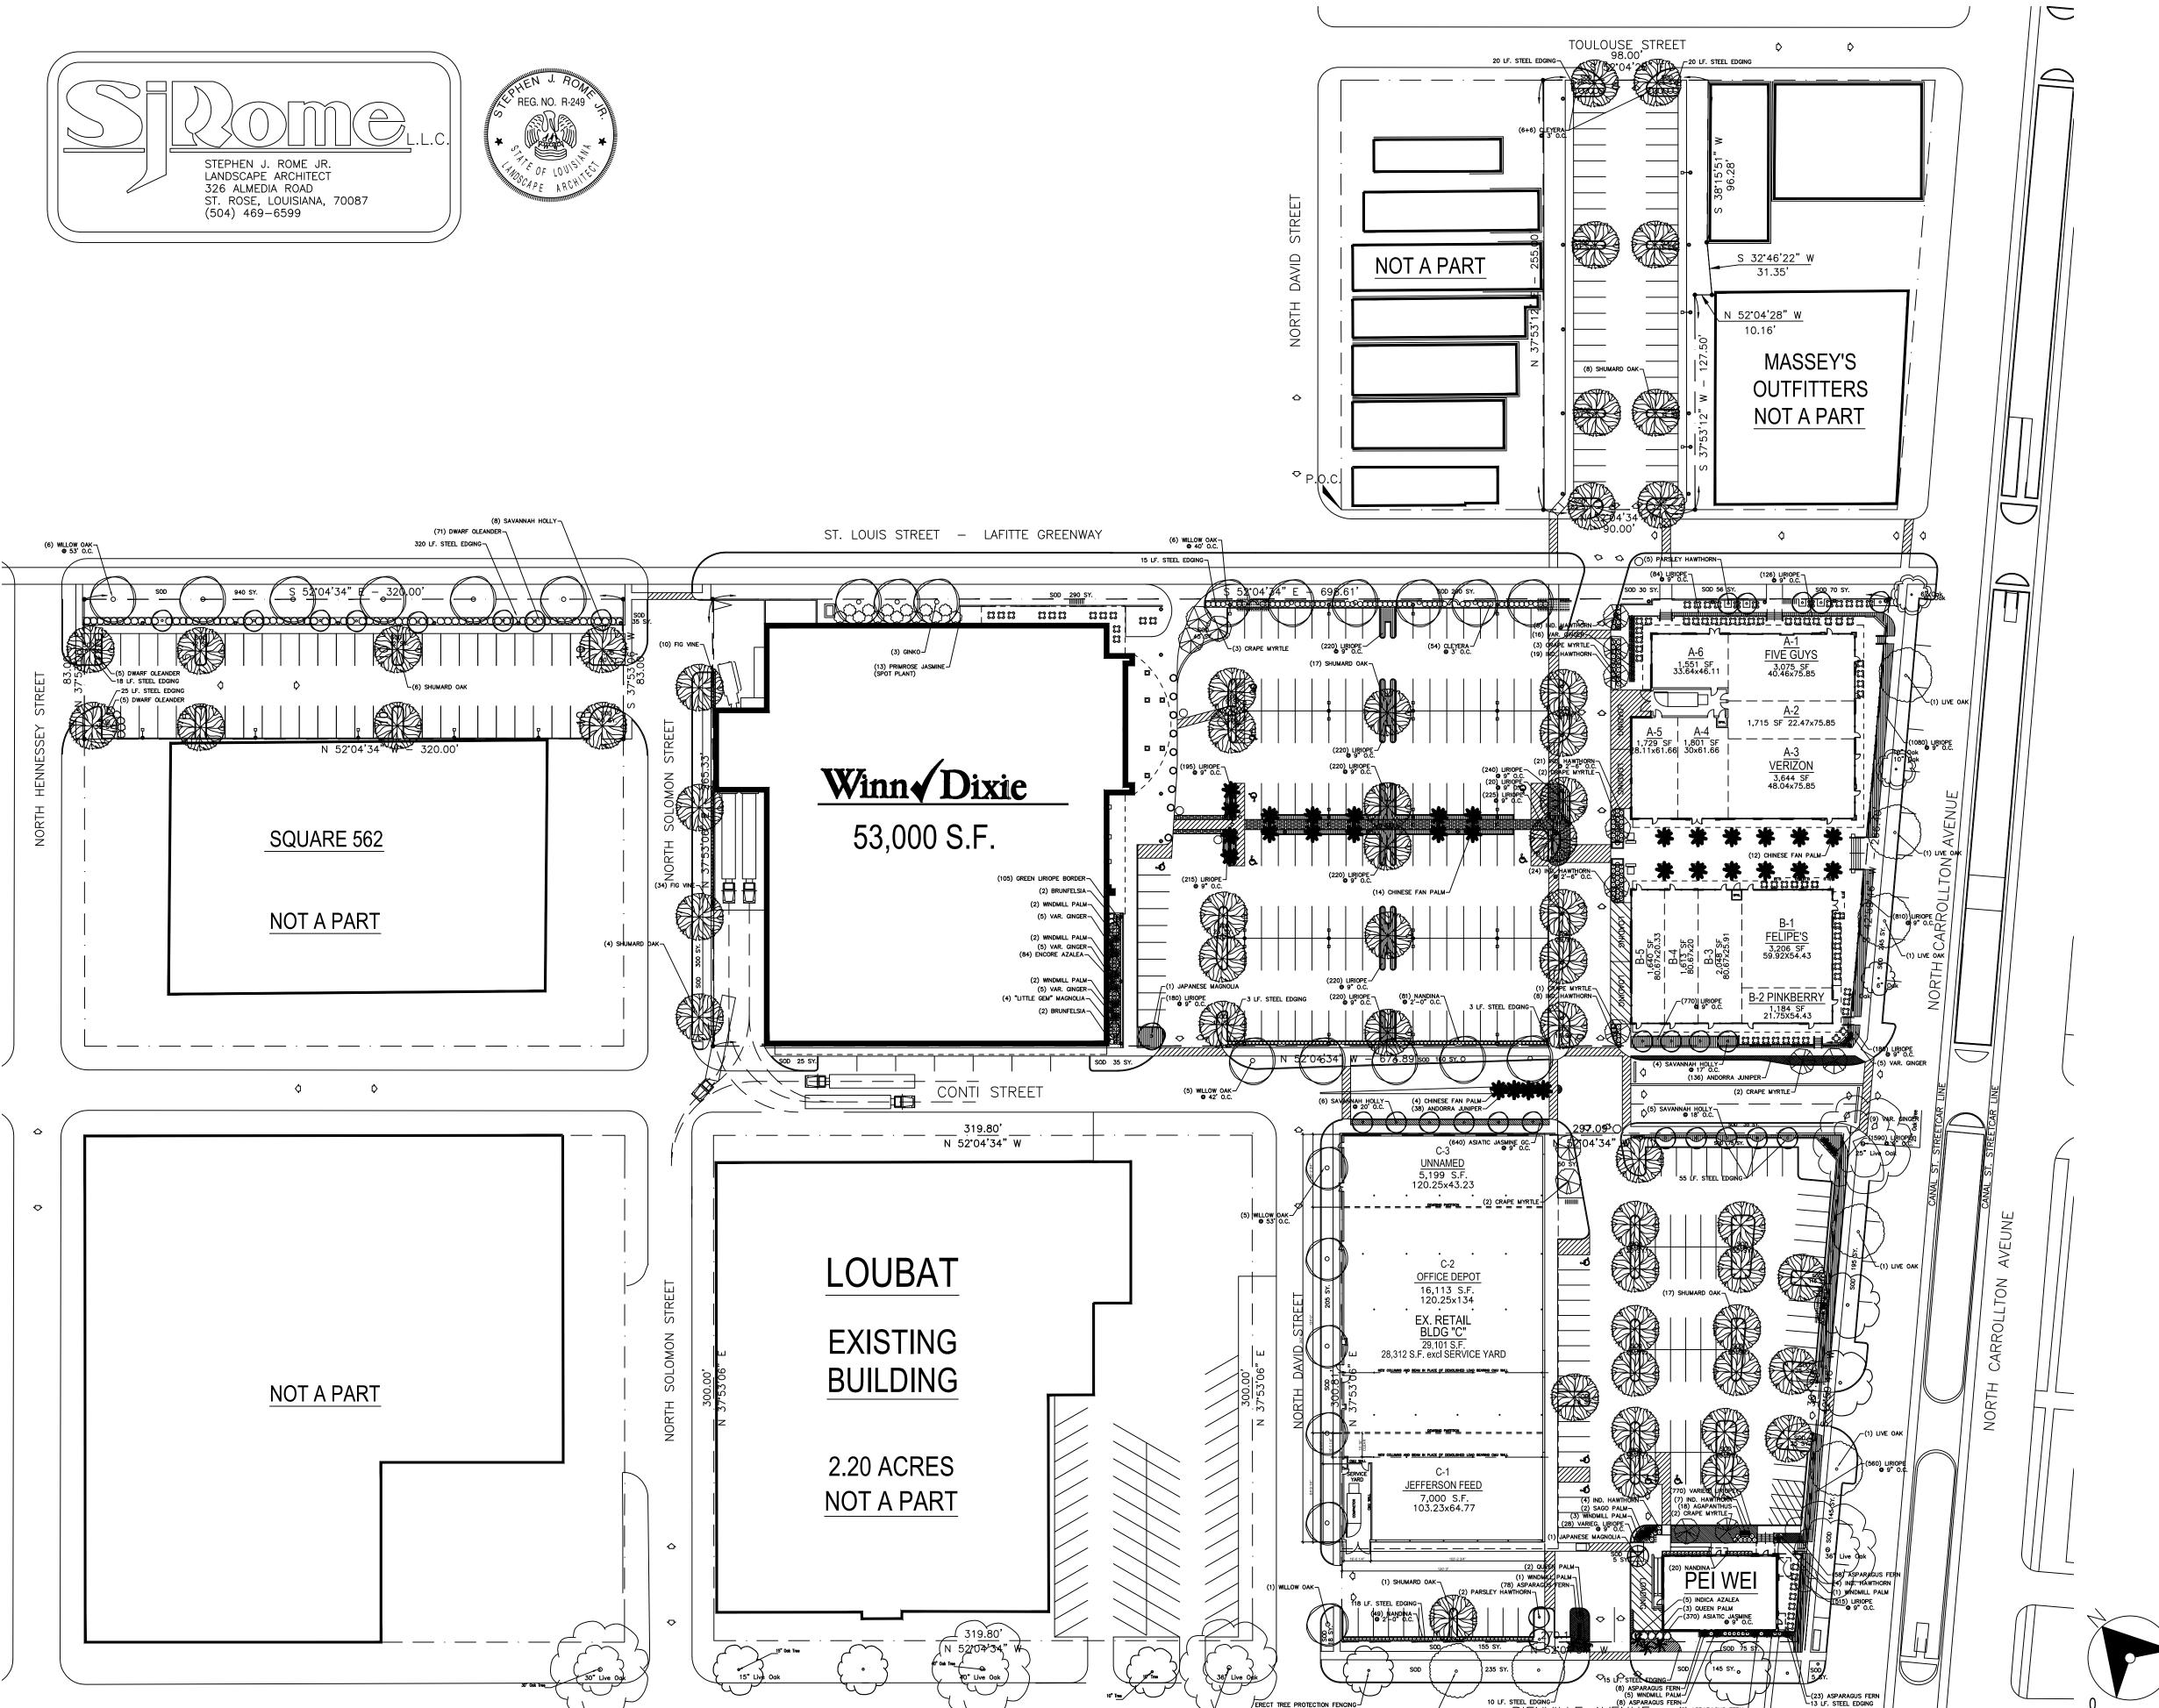



320 N. Carrollton Avenue, Suite 100 New Orleans, Louisiana 70119 t. 504.488.7739 f. 504.488.7743

> www.VergesRome.com © copyright 2011

109 Northpark Blvd., Suite 300 Covington, Louisiana 70433 t. 985.898.2022 www.stirlingproperties.com

LANDSCAPING DATA

LANDSCAPE / PAVEMENT RATIO (WD PARKING)	TOTA
LANDSCAPING AREA	7,555 9
PAVEMENT AREA	73,541 9
LANDSCAPE PERCENTAGE	10.27

SITE KEY PLAN

LEASING DATA

	ת עוג		
BUILDING AREA			TOTAL
WINN DIXIE			53,000 SF
ALL OTHER RETAIL			54,713 SF
TOTAL BUILDING AREA	A		107,713 SF
BUILDING AREA	RETAIL	RESTAURANT	TOTAL
WINN DIXIE	53,000 SF		53,000 SF
RETAIL A-1	SF	3,075 SF	3,075 SF
RETAIL A-2	1,715 SF	SF	1,715 SF
RETAIL A-3	3,644 SF	SF	3,644 SF
RETAIL A-4	1,801 SF	SF	1,801 SF
RETAIL A-5	1,729 SF	SF	1,729 SF
RETAIL A-6	1,551 SF	SF	1,551 SF
RETAIL B-1	SF	3,261 SF	3,261 SF
RETAIL B-2	SF	1,184 SF	1,184 SF
RETAIL B-3	2,302 SF	SF	2,302 SF
RETAIL B-4	3,000 SF	SF	3,000 SF
TOTAL PROPERTY A	68,742 SF	7,520 SF	76,262 SF
BUILDING AREA	RETAIL	RESTAURANT	TOTAL
RETAIL C-1	7,000 SF	SF	7,000 SF
RETAIL C-2	16,113 SF	SF	16,113 SF

SITE DATA

BUILDING AREA	RETAIL	RESTAURANT	TOTA
WINN DIXIE	53,000 SF		53,000
RETAIL "A"	10,440 SF	3,075 SF	13,515
RETAIL "B"	5,302 SF	4,445 SF	9,747
RETAIL "C"	28,312 SF		28,312
PEI WEI		3,139 SF	3,139
TOTAL	97,054 SF	10,659 SF	107,713

TOTAL PROPERTY B 28,312 SF 3,139 SF 31,451 SF

SF 5,199 SF

3,139 SF 3,139 SF

PARKING REQUIRED - PROPERTY A	
WINN DIXIE	106 @ 1:500
RETAIL - BUILDINGS "A" & "B"	63 @ 1:250
RESTAURANT - BUILDINGS "A" & "B"	50 @ 1:150
TOTAL REQUIRED PROPERTY A	219 CA
PARKING REQUIRED - PROPERTY B	
RETAIL BUILDING "C"	95 @ 1:300
RESTAURANT - PEI WEI	21 @ 1:150
TOTAL REQUIRED PROPERTY B	116 CA
TOTAL REQUIRED PROPERTIES A & B	335 CA
PARKING PROVIDED	

OFF-STREET 335 CARS 24 CARS

6.493 ACRES

SITE PLAN

SCALE 1" = 50'

OVERALL SITE PLAN SHEET:

REVISED:

REVISED:

REVISED:

REVISED:

DRAWN BY:

CHECKED BY:

CITY PLANNING COMMISSION

11003

30 SEPTEMBER 2011

17 NOVEMBER 2011

28 NOVEMBER 2011

REFER TO CITY OF NEW ORLEANS DEPARTMENT OF PARKS AND PARKWAYS SECTION 02480 AND SECTION 02481 FOR TREE PROTECTION AND INSTALLATION OF NEW PLANT MATERIAL.

LANDSCAPE NOTES


- EDGING: SHALL BE LAID IN CONFIGURATION AS SHOWN ON THE PLAN. INSTALL STEEL EDGING (1/8" X 4") WITH 1" REVEAL ON TURF SIDE AT ALL LOCATIONS WHERE PLANTING BEDS CONTACT TURF. ROUND OVER SHARP EDGES AND CORNERS WHERE EDGING ABUTS WALKS AND DRIVES.
- MULCH: ALL BEDS AND TREE PLANTING PITS ARE TO BE DRESSED WITH A MINIMUM LAYER OF 3" PINE NEEDLE MULCH.
- PRE-EMERGENT HERBICIDE: USE EPTAM GRANULES OR APPROVED EQUAL. APPLY AS PER MANUFACTURER'S RECOMMENDATIONS.
- FERTILIZER: FERTILIZE ALL NEW AND EXISTING GRASS, TREES AND SHRUBS WITH (16-10-5). USE WINTERIZER FERTILIZER (10-5-14) IF INSTALLING BETWEEN OCTOBER AND FEBRUARY.
- * FINISH GRADE: BY LANDSCAPE CONTRACTOR SHALL BE 2" BELOW ALL CURBS AND WALKS. FINISH GRADE AROUND BUILDING SHALL BE FLUSH WITH WALKS AND CURBS. TOP OF MULCH SHALL BE FLUSH WITH THE TOP OF CURBS AND WALKS, EXCEPT BEDS AROUND BUILDING . LANDSCAPE CONTRACTOR SHALL GRADE BEDS AND LAWN AREAS IN SUCH A WAY AS TO PROVIDE ADEQUATE RUN-OFF AND AVOID WATER FROM SETTING OR PUDDLING.
- PLANT PIT: ALL PITS SHALL BE CIRCULAR IN OUTLINE WITH VERTICAL SIDES AND TRUNCATED CONICAL BOTTOMS. THE MINIMUM DIAMETER OF TREE PITS SHALL BE 2'-0" GREATER THAN THE BALL OR CONTAINER.
- * PLANTING BEDS: ALL BEDS SHALL BE MOUNDED AND CROWNED NEAR THE CENTER OF THE BED A MINIMUM 6" AND TAPER TO THE PERIMETERS FLUSH WITH ADJACENT PAVING OR TURF AREAS AND 6" BELOW BUILDING/ SLAB LINE WHERE BEDS ABUT BUILDING.
- PLANTING MEDIUM: SHALL BE FERTILE, FRIABLE SOIL TYPICAL OF LOCALITY. IT SHALL BE WELL DRAINED AND HAVE A "PH" FACTOR BETWEEN 5.5 AND 7.0 WITHOUT MIXTURE OF SUBSOIL. IT SHALL BE A MIXTURE OF ONE PART HUMUS, ONE PART SAND AND ONE PART FINE GROUND PINE MULCH. IT SHALL BE CLEAN AND FREE OF CLAY, STONES, ROOTS AND WEEDS . LANDSCAPE CONTRACTOR IS RESPONSIBLE FOR SODDING ALL DAMAGED AND PROPOSED LAWN AREAS. NEW LAWN AREAS SHALL BE PROPERLY GRADED AND HAND RAKED PRIOR TO INSTALLING SOD. FINISH GRADE PRIOR TO SODDING SHALL BE 1 1/2" BELOW ALL ADJACENT WALKS AND CURBS.
- * TOPSOIL: ALL PLANTING AREAS TO RECEIVE MIXED TOPSOIL. TOPSOIL SHALL BE REPRESENTATIVE OF PRODUCTIVE SOILS IN THE AREA AND SHALL NOT BE EXCESSIVELY ACID OR ALKALINE.
- * PLANT QUALITY: PLANT MATERIAL SHALL HAVE A HABIT OF GROWTH WHICH IS NORMAL FOR THE SPECIES AND SHALL BE SOUND, HEALTHY, FREE OF DISEASE, ETC.

GENERAL LANDSCAPE NOTES


- THE LANDSCAPE CONTRACTOR SHALL PROVIDE ALL MATERIALS, LABOR AND EQUIPMENT NECESSARY TO COMPLETE ALL LANDSCAPE WORK AS SHOWN ON THE PLANS AND SPECS.
- 2 ALL PLANT MATERIAL WILL CONFORM TO THE CURRENT ISSUE OF THE AMERICAN STANDARD FOR NURSERY STOCK PUBLISHED BY THE
- 3 DURING PLANTING, ALL AREAS SHALL BE KEPT NEAT AND CLEAN, AND ALL REASONABLE PRECAUTIONS SHALL BE TAKEN TO AVOID DAMAGE TO EXISTING PLANTS, TURF AND STRUCTURES.
- 4 UPON COMPLETION, ALL DEBRIS AND WASTE MATERIAL RESULTING FROM PLANTING OPERATIONS SHALL BE REMOVED FROM THE PROJECT AND THE AREA CLEANED UP.
- 5 ANY DAMAGED AREAS SHALL BE RESTORED TO THEIR ORIGINAL CONDITION.
- 6 IF AVAILABLE ON THE SITE , THE OWNER SHALL SUPPLY WATER AT NO COST TO THE LANDSCAPE CONTRACTOR. IT WILL BE THE LANDSCAPE CONTRACTOR'S RESPONSIBILITY TO SUPPLY WATER IF THERE IS NONE ON
- 7 WARRANTY: ALL GROUNDCOVER, SHRUBS, AND TREES ARE TO BE WARRANTED FOR A PERIOD OF ONE YEAR. WARRANTY BEGINS AT THE APPROVAL OF THE COMPLETED PROJECT.
- 8 LANDSCAPE CONTRACTOR SHALL BE RESPONSIBLE FOR MAKING HIMSELF FAMILIAR WITH ALL UNDERGROUND PIPES, UTILITIES, STRUCTURES, ETC.
- 9 LANDSCAPE CONTRACTOR SHALL BE RESPONSIBLE FOR MAINTAINING ALL SHRUB AND PLANTING AREAS IN A WEED AND DEBRIS FREE CONDITION UNTIL FINAL ACCEPTANCE
- 10 CONTRACTOR IS RESPONSIBLE FOR VERIFICATION OF ALL QUANTITIES PER DRAWINGS AND SPECIFICATIONS BY THE LANDSCAPE ARCHITECT. PLANT QUANTITIES HAVE BEEN PROVIDED FOR CONVENIENCE TO THE CONTRACTOR AND SHALL NOT BE CONSIDERED ABSOLUTE. CONTRACTOR TO BID HIS OWN VERIFIED QUANTITIES.
- 11 ALL LAWN AREAS SHALL BE SOLID SOD CENTIPEDE GRASS.
- 12 ALL LANDSCAPE AREAS TO BE WATERED BY IRRIGATION SYSTEM.


LANDSCAPE AND BUFFER MAINTENANCE NOTATION

- 1 THE OWNER, TENANT OR THEIR AGENT, IF ANY SHALL BE JOINTLY AND SEVERALLY RESPONSIBLE FOR THE MAINTENANCE OF ALL LANDSCAPING.
- 2 ALL PLANT MATERIALS SHALL BE MAINTAINED IN A HEALTHY AND GROWING CONDITION AS IS APPROPRIATE FOR THE SEASON OF THE YEAR.
- 3 PLANT MATERIALS WHICH DIE SHALL BE REPLACED WITH SIMILAR HEALTHY PLANT MATERIALS.
- 4 LANDSCAPE AREAS WITHIN SITE TRIANGLES SHALL BE MAINTAINED IN AN APPROPRIATE MANNER TO INSURE THAT NO PLANT MATERIAL OBSTRUCTS CROSS-VISIBILITY ABOVE (3) FEET OR BELOW SIX (6) FEET FROM THE STREET OR ACCESS WAY GRADE.
- 5 ALL LANDSCAPING SHALL BE MAINTAINED IN A NEAT AND ORDERLY MANNER AT ALL TIMES. THIS SHALL INCLUDE MOWING, EDGING, PRUNING, FERTILIZING, WATERING, WEEDING AND OTHER SUCH ACTIVITIES COMMON TO MAINTENANCE OF LANDSCAPING.
- 6 LANDSCAPE AREAS SHALL BE KEPT FREE OF TRASH, LITTER, WEEDS AND OTHER SUCH MATERIAL OR PLANTS NOT PART OF THE LANDSCAPING.

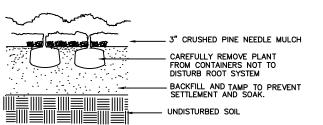

GROUNDCOVER DETAIL

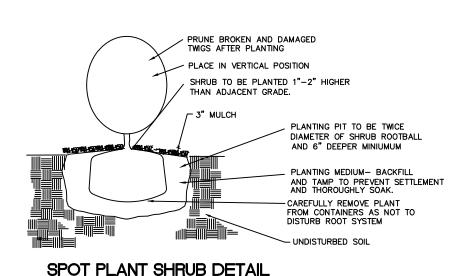

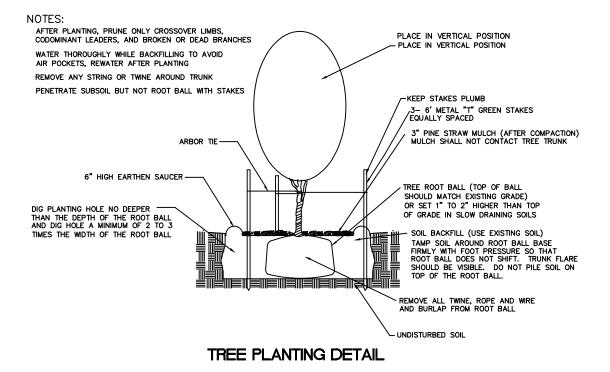


5' HIGH CHAIN LINK FENCE


TREE PROTECTION DETAIL


POLES @ 10' O.C. MAX

FENCE LOCATION = LIMITS OF ROOT ZONE

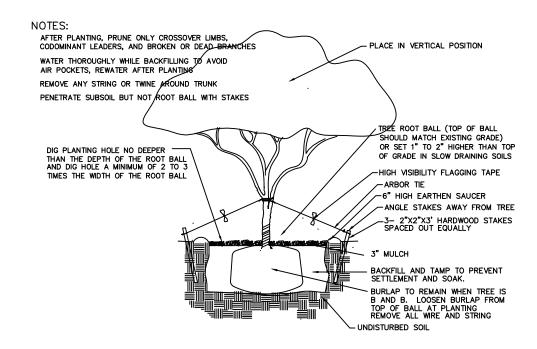

MULTI-TRUNK TREE PLANTING DETAIL

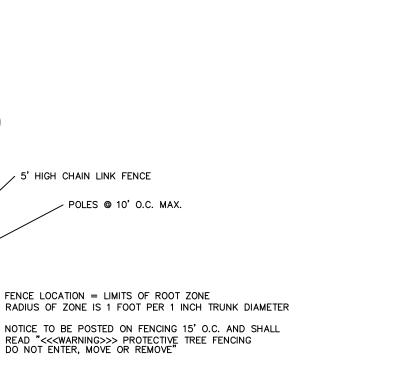

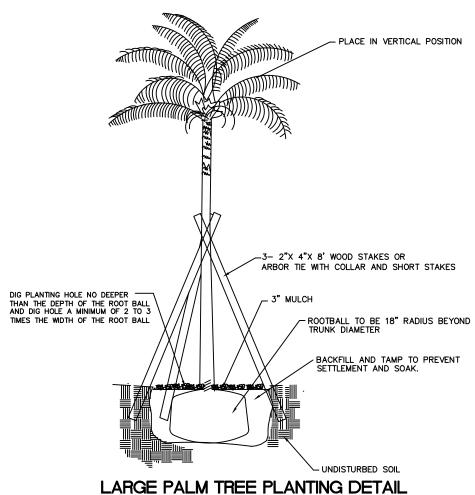



Architects

320 N. Carrollton Avenue. Suite 100 New Orleans, Louisiana 70119 t. 504.488.7739 f. 504.488.7743

> www.VergesRome.com © copyright 2011

109 Northpark Blvd., Suite 300 Covington, Louisiana 70433 t. 985.898.2022 www.stirlingproperties.com

30 SEPTEMBER 2011 DATEISSUED: 29 NOVEMBER 2011 REVISED: REVISED: REVISED: REVISED: DRAWN BY: CHECKED BY:

> CITY PLANNING COMMISSION

TITLE: **OVERALL** SITE PLAN

SHEET:



DESCRIPTION

The Acorn tastefully compliments roadways, parks and residential roadways.



Catalog #	Туре
Project	
	Date
Comments	2010
Prepared by	

SPECIFICATION FEATURES

Construction

HOUSING: Cast aluminum housing. Standard with two position terminal block. Seven standard color options. Other finish colors available. PHOTOCONTROL: NEMA PCR photocontrol receptacle available. Accessible through door assembly.

Electrical

SOCKET: Mogul-base socket for HPS and 250W Metal Halide; 50W through 175W Metal Halide is medium base socket. All sockets are 4KV pulse rated. BALLAST: Easily accessable, tilt-back power module. Standard plug-in starter when applicable.

Optical

GLOBE: Textured polycarbonate globes (Optional internal Type III refractor available)

Mounting

Post-top mount fits 3" tenons. Stainless steel mounting bolts.




ARN **ACORN**

50 - 250W **Pulse Start Metal Halide Metal Halide High Pressure Sodium**

DECORATIVE LUMINAIRE

DIMENSIONS

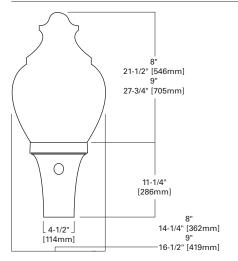

Wattage Pulse Start Metal Halide (MP) 50, 70, 100, 150, 200, 250W

175, 250W

High Pressure Sodium (HPS) 50, 70, 100, 150W

FINIAL OPTIONS









ENERGY DATA

Hi-Reactance Ballast Input Watts

50W HPS HPF (62 Watts) 50W MP HPF (69 Watts) 70W HPS HPF (86 Watts) 70W MP HPF (94 Watts) 100W HPS HPF (115 Watts) 100W MP HPF (129 Watts) 150W HPS HPF (170 Watts) 150W MP HPF (185 Watts)

CWA Ballast Input Watts

175W MP HPF (198 Watts) © 200W MP HPF (227 Watts) ® 250W MP HPF (283 Watts) ®

Effective Projected Area: (Sq. Ft.)

SHIPPING DATA **Approximate Net Weight:**

30 lbs. (14 kgs.)




WATTAGE TABLE


Metal Halide (MH)



PHOTOMETRICS

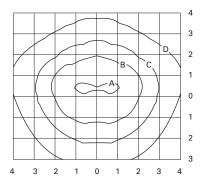

ARN-100-HPS-3-AV 100-Watt HPS 9,500-Lumen Lamp Type III

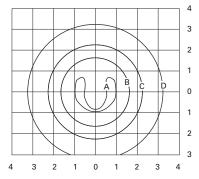


ARN-100-HPS-5-AV 100-Watt HPS 9,500-Lumen Lamp Type V

Footcandle Table

Select mounting height and read across for footcandle values of each isofootcandle line. Distance in units of mounting height.

Mounting Height	Footcandle Values for Isofootcandle Lines			
	Α	В	С	D
12'	1.36	0.68	0.34	0.13
14'	1.00	0.50	0.25	0.10
16'	0.76	0.38	0.19	0.07

ORDERING INFORMATION

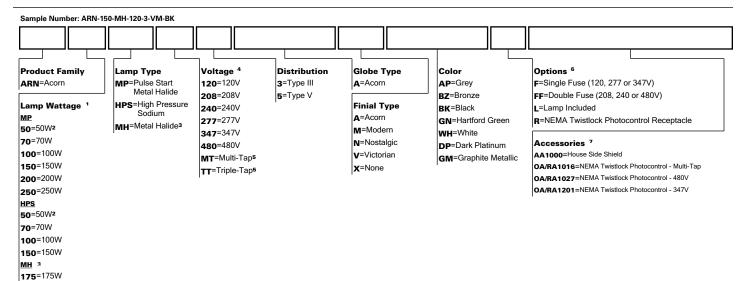

- Notes: 1 Standard with Mogul-base socket for HPS and 250W Metal Halide. Standard with medium-base socket for 50 175W Metal Halide.
 - 2 Available in 120V only

250=250W

- 3 175 and 250W available for non-US markets only.
- Products also available in non-US voltages and 50Hz for international markets. Consult factory for availability and ordering information.
- Multi-Tap ballast is 120/208/240/277V wired 277V. Triple-Tap ballast is 120/277/347V wired 347V.
- 6 Add as suffix in the order shown.
- 7 Order separately, replace XX with color suffix.



DESCRIPTION

The patent pending Lumark Crosstour™ LED Wall Pack Series of luminaries provides an architectural style with super bright, energy efficient LEDs. The low-profile, rugged die-cast aluminum construction, universal back box, stainless steel hardware along with a sealed and gasketed optical compartment make the Crosstour impervious to contaminants. The Crosstour wall luminaire is ideal for wall/surface, inverted mount for façade/canopy illumination, post/bollard and low level pathway illumination including stairs. Typical applications include building entrances, multi-use facilities, apartment buildings, institutions, schools, stairways and loading docks.

Catalog #	Туре
Project	
Comments	Date
Prepared by	

SPECIFICATION FEATURES

Construction

Slim, low profile LED design with rugged one-piece, die-cast aluminum hinged removable door and back box. Matching housing styles incorporate both a small and large design. The small housing is available in 10W and 20W. The large housing is available in the 30W model. Patent pending secure lock hinge feature allows for safe and easy tool-less electrical connections with the supplied lever-lock connectors. Back box includes three (3) half-inch, NPT threaded conduit entry points. The universal back box supports both the small and large forms and mounts to standard 3-1/2" to 4" round and octagonal, 4" square, single gang and masonry junction boxes. Key hole gasket allows for adaptation to junction box or wall. External fin design extracts heat from the fixture surface. One-piece silicone gasket seals door and back box. Not recommended for car wash applications.

Optical

Silicone sealed optical LED chamber incorporates a custom engineered mirrored anodized reflector providing high-efficiency illumination. Optical assembly includes impact-resistant tempered glass and meets IESNA requirements for full cutoff compliance. Solid state LED Crosstour luminaries are thermally optimized with five (5) lumen packages in cool 5000K or neutral warm 3500K LED color temperature (CCT).

Electrical

LED driver is mounted to the diecast housing for optimal heat sinking. LED thermal management system incorporates both conduction and natural convection to transfer heat rapidly away from the LED source. 10W models operate in -40°C to 40°C [-40°F to 104°F]. 20W and 30W models operate in -30°C to 40°C [-22°F to 104°F]. Crosstour luminaires

maintain greater than 70% of initial light output after 50,000 hours of operation. Three (3) half-inch NPT threaded conduit entry points allow for thru-branch wiring. Back box is an authorized electrical wiring compartment. Integral LED electronic driver incorporates surge protection. 10W, 120V 50/60 Hz., 20W and 30W, 120-277V 50/60Hz.

Finish

Crosstour is protected with a Super TGIC carbon bronze or summit white polyester powder coat paint. Super TGIC powder coat paint finishes withstand extreme climate conditions while providing optimal color and gloss retention of the installed life.

Warrantv

Crosstour features a five-year limited warranty.



LUMARK®


XTOR CROSSTOUR LED

WALL / SURFACE MOUNT POST / BOLLARD MOUNT LOW LEVEL MOUNT INVERTED MOUNT

SustainabL Design



DIMENSIONS

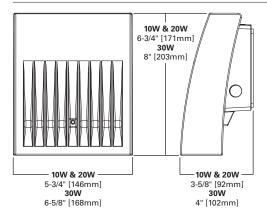

CERTIFICATION DATA

UL/cUL Wet Location Listed IP66 Ingress Protection Rated ADA Compliant LM79 / LM80 Compliant ROHS Compliant ARRA Compliant DLC Qualified Models Lighting Facts® Approved Title 24 Compliant

TECHNICAL DATA

40°C Maximum Ambient Temperature External Supply Wiring 90°C Minimum


SHIPPING DATA: Approximate Net Weight: 3.7 - 5.25 lbs. [1.7 - 2.4 kgs.]

ADH111091 pc

2011-10-06 08:07:05

ORDERING INFORMATION

SAMPLE NUMBER: XTOR2A-N-WT-PC1

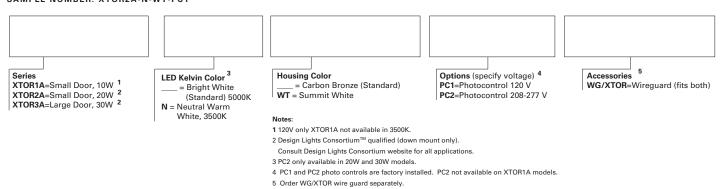

STOCK ORDERING INFORMATION

10W Series	20W Series	30W Series
XTOR1A = 10W, 5000K, Carbon Bronze	XTOR2A = 20W, 5000K, Carbon Bronze	XTOR3A = 30W, 5000K, Carbon Bronze
XTOR1A-WT = 10W, 5000K, Summit White	XTOR2A-N = 20W, 3500K, Carbon Bronze	XTOR3A-N = 30W, 3500K, Carbon Bronze
XTOR1A-PC1 = 10W, 5000K, 120V PC, Carbon Bronze	XTOR2A-WT = 20W, Summit White	XTOR3A-WT = 30W, Summit White
	XTOR2A-PC1 = 20W, 120V PC, Carbon Bronze	XTORA3A-PC1 = 30W, 120V PC, Carbon Bronze



5-DAY QUICK SHIP ORDERING INFORMATION

10W Series	20W Series	30W Series
XTOR1A-WT-PC1 = 10W, 5000K, Summit White,120V PC	XTOR2A-PC2 = 20W, 5000K, 208-277V PC, Carbon Bronze	XTOR3A-PC2 = 30W, 5000K, 208-277V PC, Carbon Bronze
	XTOR2A-WT-PC1 = 20W, 5000K, Summit White, 120V PC	XTOR3A-WT-PC1 = 30W, 5000K, Summit White, 120V PC
	XTOR2A-WT-PC2 = 20W, 5000K, Summit White, 208-277V PC	XTOR3 A - WT - PC2 = 30W, 5000K, Summit White, 208-277V PC
	XTOR2A-N-WT = 20W, 3500K, Summit White	XTOR3A-N-WT = 30W, 3500K, Summit White
	XTOR2A-N-PC1 = 20W, 3500K, 120V PC, Carbon Bronze	XTOR3A - N - PC1 = 30W, 3500K, 120V PC, Carbon Bronze
	XTOR2A-N-PC2= 20W, 3500K, 208-277V PC, Carbon Bronze	XTOR3A - N - PC2= 30W, 3500K, 208-277V PC, Carbon Bronze
	XTOR2A-N-WT-PC1= 20W, 3500K, Summit White, 120V PC	XTOR3 A-N-WT-PC1 = 30W, 3500K, Summit White, 120V PC
	XTOR2A-N-WT-PC2 = 20W, 3500K, Summit White, 208-277V PC	XTOR3A-N-WT-PC2 = 30W, 3500K, Summit White, 208-277V PC

CURRENT DRAW

	XTOR1A	XTOR2A	XTOR3A
120V	.13A	0.2A	0.3A
208V		0.1A	0.15A
240V		0.15A	0.15A
277V		0.15A	0.15A



COOPER LIGHTING - LUMARK®

DESCRIPTION

The Lumark Tribute is the most versatile, functionally designed, universally adaptable outdoor luminaire available. The Tribute brings outstanding performance to walkways, parking lots, roadways, loading docks, building areas, and any security lighting application. U.L. listed and CSA certified for wet locations.

Catalog #	Туре
Project	
Comments	Date
Prepared by	

SPECIFICATION FEATURES

Construction

Rugged one-piece die-cast aluminum housing and door frame. One-piece silicone gasket protects the optical chamber from performance degrading contaminants. One (1) stainless spring latch and two (2) stainless hinges allow toolless opening and removal of door frame.

Reflector

Choice of nine (9) high efficiency optical distributions, including five (5) segmented optical systems constructed of premium 95% reflective odized aluminum sheet. Optical segments are rigidly mounted inside a thick gauge aluminum housing for superior protection. All segment faces are clean of rivet heads, tabs or other means of attachment which may cause streaking in the light distribution. Optical modules are

field rotatable in 90° increments and offered standard with mogul base lampholders for High Pressure Sodium and 200-400W Metal Halide assemblies or medium-base lampholders for Metal Halide 150W and below.

Electrical

Ballast and related electrical componentry are hard mounted to die-cast housing for optimal heat transfer and operating efficiency. Optional swing-down galvanized steel power tray with integral handle and quick disconnects allows tray to be completely removed from housing providing ample room for fixture installation and maintenance.

Mounting

Extruded 8" aluminum arm features internal bolt guides for easy positioning of fixture during installation to pole or wall surface.

Standard single carton packaging of housing, square pole arm and round pole adapter allow for consolidated product arrival to site. Optional internal mast arm mount accepts a 1 1/4" to 2 3/8" O.D. horizontal tenon, while a 4-bolt clamping mechanism secures fixture. Cast-in leveling guides provide +/-5° vertical leveling adjustment.

Finish

Housing and arm finished in a 5 stage premium TGIC bronze polyester powder coat paint. Optional colors include black, grey, white, dark platinum and graphite metallic. RAL and custom color matches available.



TRIBUTE

70 - 400W

High Pressure Sodium Pulse Start Metal Halide Metal Halide

AREA LUMINAIRE



TECHNICAL DATA

UL Wet Locations Listed EISA Compliant (E)

ENERGY DATA

Hi-Reactance Ballast Input Watts

70W HPS HPF (95 Watts) 100W HPS HPF (130 Watts) 150W HPS HPF (190 Watts) 150W MP HPF (185 Watts)

CWI Ballast Input Watts 250W HPS HPF (300 Watts)

CWA Ballast Input Watts

175W MH HPF (210 Watts) 200W MP HPF (227 Watts) ® 200W HPS HPF (250 Watts) 250W MH HPF (295 Watts)

250W MP HPF (283 Watts) (E)

320W MP HPF (365 Watts) ®

350W MP HPF (397 Watts) (E)

400W MP HPF (452 Watts) (E)


400W MH HPF (455 Watts) 400W HPS HPF (465 Watts)

Effective Projected Area: (Sq. Ft.) Without Arm: 1.19

SHIPPING DATA Approximate Net Weight: 39 lbs. (17.73 kgs.)




DIMENSIONS

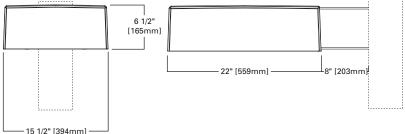


DRILLING PATTERNS


TYPE "M"

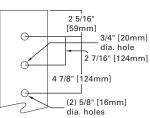


WALL MOUNT (MA1219-XX)

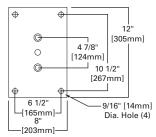


TRUNNION MOUNT

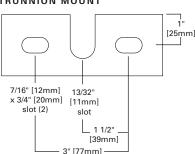

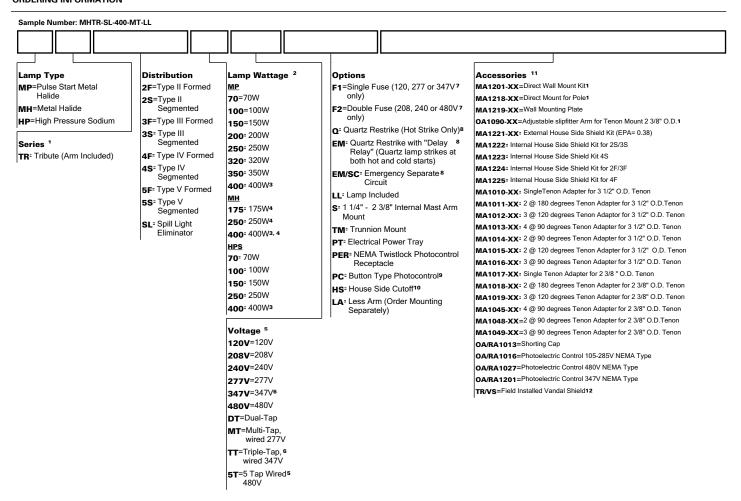

1 8 Inch Arm and pole adapter included with fixture. Specify Less Arm "LA" option when mounting accessory is ordered separately. 2 150W and below in Metal Halide are medium base sockets. All other wattages are mogul base. 3 Requires reduced envelope lamp. 4 175W, 250W, and 400W MH available in non-U.S. markets only. 5 Products also available in non-US voltages and 50HZ for international markets. Consult your Cooper Representative for availability and ordering information. 5T only available in 400W MH. 6 88% efficient EISA Compliant MP fixtures not available in 347V or TT Voltages. 7 Must specify voltage. 8 Quartz options not available with SL optics. 9 PC not available in 480V. 10 House side shield not available on 5S, 5F, or SL optics. 11 Order separately/replace XX with color specification. 12 Not available with SLE or House Side Sheild.

STOCK SAMPLE NUMBER (Lamp Included)

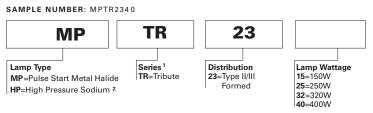


NOTES:

¹ Short logic fixtures are finished bronze include multi-tap ballast, lamp, arm and round pole adapter. Other options not available. Refer to standard ordering logic. ² Available in 150, 250 and 400 Watt. Refer to In Stock Guide for availability

VOLTAGE CHART	
DT=Dual-Tap	120/277 (wired 277V)
MT=Multi-Tap	120/208/240/277 (wired 277V)
TT=Triple-Tap	120/277/347 (wired 347V)
5T=5-Tap	120/208/240/277/480 (wired 480V)

LAMP TYPE	WATTAGE
Pulse Start Metal Halide	70, 100, 150, 250, 320, 350, 400W
Metal Halide	175, 250, 400W
High Pressure Sodium	70, 100, 150, 250, 400W



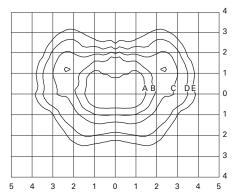

MPTR-3S-320


320-Watt MP

30,000-Lumen Clear Lamp

Type III Segmented

Footcandle Table
Select mounting height and read across for footcandle values of each isofootcandle line. Distance in units of mounting height.

Mounting	Footca	ndle Valu	es for		
Height	Isofoo	candle Li	nes		
	Α	В	С	D	E
20'	3.00	1.50	0.75	0.30	0.15
25'	2.00	1.00	0.50	0.20	0.10
30'	1.38	0.69	0.34	0.13	0.06

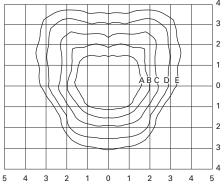

MPTR-4S-400

400-Watt MP


40,000-Lumen Clear Lamp

Type IV Segmented

Footcandle Table

Select mounting height and read across for footcandle values of each isofootcandle line. Distance in units of mounting height.

Mounting Height		ndle Valu candle Li			
	Α	В	С	D	Е
20'	3.00	1.50	0.75	0.30	0.15
25'	2.00	1.00	0.50	0.20	0.10
30,	1 38	0.69	0.34	0.13	0.06

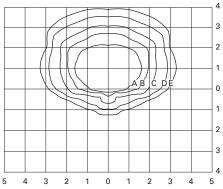

MPTR-SL-400

400-Watt MP

40,000-Lumen Clear Lamp

Spill Light Eliminator

Footcandle Table

Select mounting height and read across for footcandle values of each isofootcandle line. Distance in units of mounting height.

Mounting	Footca	ndle Valu	es for		
Height	Isofoot	candle Li	nes		
	Α	В	С	D	Е
20'	3.00	1.50	0.75	0.30	0.15
25'	2.00	1.00	0.50	0.20	0.10
30'	1.38	0.69	0.34	0.13	0.06

MOUNTING CONFIGURATIONS

Wall Mount	Arm Mount Single EPA: 1.62	Arm Mount 2 @ 180 EPA: 3.24	Arm Mount 2 @ 90 EPA: 3.24	Arm Mount 3 @ 120 (Round Pole Only) EPA: 4.43	Arm Mount 3 @ 90 EPA: 4.43	Arm Mount 4 @ 90 EPA: 5.03







DESCRIPTION

The classic lines and sophisticated construction of the Vision Site luminaire make it an ideal complement to site design. The combination of smooth contours and sharp rear reveals allows the fixture to change character from different viewing angles while providing excellent lowglare photometrics. U.L. listed and CSA certified for wet locations.

Catalog #	Туре
Project	
	Date
Comments	Duits

SPECIFICATION FEATURES

Construction

HOUSING: One-piece, die-cast aluminum housing maintains a nominal 0.125" wall thickness. Integral reveal channels along top surface of housing promote heat extraction and prolonged electrical component life. Solid cast wall separates optical chamber from electrical area. DOOR: One-piece die-cast aluminum door frame. Door frame opens via release of two flush mounted toolless latches. Tempered 1/8" thick clear glass lens seals to door with a weather-tight continuous gasket. Optical chamber is sealed against entry of dirt and moisture by a continuous door mounted gasket which firmly compresses against optical enclosure walls. ARM: One-piece extruded rectangular arm available in standard 6" and 10" lengths. Internal bolt guides allow easy positioning of fixture during installation to pole or wall surface. STRUCTURAL MOUNT: Die-cast aluminum cleat factory mounted to luminaire and finished in luminaire color. Stainless steel structural rod measures 1/2" in diameter and is provided in luminaire finish color or optional natural finish. Product

works in conjunction with accessory 10" arms. INVUE poles provided pre-drilled for suspension mount option. See INVUE pole brochure for a complete selection of matching poles.

Electrical

ELECTRICALTRAY: Ballast and related electrical componentry are mounted to a reinforced one piece galvanized steel tray with integral handle. For ease of maintenance, tray hinges open via toolless release of one spring loaded latch. Electrical quick disconnects allow tray to be completely removed from housing providing ample hand and tool room for attachment of fixture during installation, and a safer servicing environment. Optional tray mounted fuse connections offer a distinct and easy to maintain alternative to common inline fuse connections.

Optical

LENS: Impact resistant 1/8" thick tempered clear flat glass. OPTICAL SYSTEMS: Choice of five (5) efficiency segmented optical systems constructed of premium 95% reflective anodized aluminum

sheet. Optical segments are rigidly mounted inside a thick gauge aluminum housing for superior protection. All segment faces are clean of rivet heads, tabs, or other means of attachment which may cause streaking in the light distribution. Optional high efficiency hydroformed reflectors available in VXM housing only in four (4) distributions patterns. All reflector modules feature toolless removal, quick disconnect wiring plugs, and are field rotatable in 90 degree increments. HID lamp sources in medium housing (VXM) optics feature mogul-base lampholders.

Finish

Housing and arm finished in a 5 stage premium TGIC polyester powder coat paint, 2.5 mil nominal thickness for superior protection against fade and wear. Standard colors include black, bronze, grey, white, dark platinum, and graphite metallic. RAL and custom color matches available. Consult your **INVUE Lighting Systems** Representative for more information.



VISION SITE **MEDIUM**

84 - 400W **Pulse Start Metal Halide** Metal Halide **High Pressure Sodium Compact Fluorescent**

> ARCHITECTURAL AREA LUMINAIRE

DIMENSIONS [178mm] 17" [432 mm] 28" [724 mm] 6" or 10" [152 mm or 254 mm]

WATTAGE TABLE

Lamp Type	Wattage
Pulse Start Metal Halide (MP)®	150, 175, 250, 320, 350, 400W
High Pressure Sodium (HPS)	150, 250, 400W
Metal Halide (MH)	175, 250, 400W
Compact Fluorescent (CF)	(2) 42, (2) 57W
NOTE: (F) FISA Compliant: 175-400W	





CERTIFICATION DATA

IP54 Rated U.L. 1598 Listed 1.5G Vibration Tested CSA Listed 40°C Ambient Temperature Rating ISO 9001 Full Cutoff

Effective Projected Area: (Sa. Ft.)

Single: 1.6 Single Structural: 1.82


SHIPPING DATA (Approximate)

Net Weight (lbs.): 51 Volume (cu. ft): 3.18




ARM DRILLING


TYPF "M"

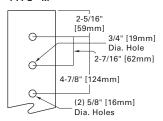

STRUCTURAL MOUNT

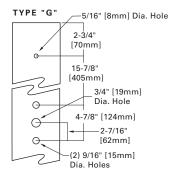

MAST ARM ADAPTER

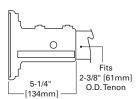

MOUNTING VARIATIONS

_

Wall Mount

Arm Mount Single EPA: 1.6 Arm Mount 2 @ 180° EPA: 3.2 Arm Mount 2 @ 90° EPA: 3.2 Arm Mount 3 @ 120° (Round Pole Only) EPA: 4.5 Arm Mount 3 @ 90° EPA: 4.5 Arm Mount 4 @ 90° EPA: 5.55












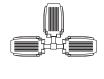



NOTE: 1 Assumes 10" arm for 90° and 120° mounting configurations, 6" for all else.

ORDERING INFORMATION

Sample Number: VXM-400-MH-MT-3S-BK-PRCPS-L Product Family 1 Optical System .amp Type VXM=Vision Site Medium MP=Pulse Start Metal 2S=Type II Halide 3S=Type III MH=Metal Halide Lamp Wattage ² 4S=Type IV **HPS**=High Pressure MP 5S=Type V 150=150W Sodium SL=Forward Throw w/ 175=175W Compact 6 Spill Light Eliminator Fluorescent 250=250W 2F=Design 20 Formed 320=320W 3F=Design 30 Formed Voltage 7 350=350W 4F=Design 40 Formed 120=120V 400=400W3 5F=Design 50 Formed 208=208V MH 4 240=240V 175=175W Color 11 **277**=277V 250=250W BK=Black **347**=347V 400=400W³ AP=Grev 480=480V HPS BZ=Bronze DT=Dual-Tap wired8 150=150W WH=White 277V 250=250W DP=Dark Platinum MT=Multi-Tap wired9 400=400W 277V GM=Graphite Metallic Compact Fluorescent TT=Triple-Tap wired10 84=(2) 42W5 347V UNV=120-277V 114: (2) 57W5 Universal Electronic Ballast

Notes: 1 Arm not included. See accessories. 2 Standard with mogul-base socket for HPS, MH and 175-400W MP. Standard with medium-base socket for MP lamps 150W and below. 3 400W MH and PSMH requires reduced envelope ED28 lamp. 4 MH products available for non-U.S. markets only. 5 Dual Compact Fluorescent lamp options available in Type 25 with 84 and 114W. Type 3S available in 84W only. 6 CF ballasts are 120 through 277V. Specify with UNV voltage designation. 7 Products also available in non-US voltages and 50Hz for international markets. Consult factory for availability and ordering information. 8 Dual-tap is 120/277V wired 277V. 9 Multi-tap is 120/208/240/277V wired 277V. 10 Triple-tap is 120/277/347V wired 347V. 11 Custom and RAL color matching available upon request. Consult your INVUE Lighting Systems Representative for further information. 12 Add as suffix in the order shown. 13 Compatible with 10" MA1051 arm only. 14 Compatible with 10" MA1053 arm only. 15 Wall mount structual options do not include arm assembly (See Accessories). Compatible with 10" MA1231 arm only. 16 Cuartz options not available with SL optic. 17 Dual switching requires dual 42W or dual 57W Compact Fluorescent lamps. Allows independent switching control of each lamp through use of two (2) electronic ballasts. Allows 50% power reduction when dual ballasts are independently wired and controlled. 18 House side shield not available on 55 and SL optics. 19 Order separately, replace XX with color suffix. 20 Use when mounting fixture heads at 90° increments. 21 For use in down lighting applications only. 22 Includes arm only. Must specify WRCP or WRCS in fixture ordering logic. Down light only.

Structural Options 1. 12

Pole Mount

PRCPS=Strut Rod and Clevis Set for Square Pole (Painted to match fixture, does not include arm)

PRCSS=Stainless Steel Strut Rod and
Clevis Set for Square Poles
(Clevis' painted to match fixture,
does not include arm)

PRCPR=Strut Rod and Clevis Set for Round Pole (Painted to match fixture, does not include arm)

PRCSR=Stainless Steel Strut Rod and Clevis Set for Round Poles (Clevis' painted to match fixture, does not include arm)

Wall Mount

WRCP=Strut Rod and Clevis Set (Painted 15 to match fixture, does not include arm)

WRCS=Stainless Steel Strut Rod and 15 Clevis Set (Clevis' painted to match fixture, does not include arm)

Options 12

F= Single Fuse (120, 277 or 347V) Specify Voltage

FF= Double Fuse (208, 240 or 480V) Specify Voltage

Q= Quartz Restrike16

EM= Quartz Restrike w/ Time Delay (Also 16 Strikes at Cold Start)

EM/SC= Quartz Emergency Separate 16 Circuit

R⁼ NEMA Twistlock Photocell Receptacle

DS⁼ Dual Fluorescent Switching Control¹⁷

DS: Dual Fluorescent Switching

HS: House Side Shield18

vs- Polycarbonate Vandal Shield

T= Terminal Block

L= Lamp Included

Accessories 19

MA1050-XX=6" Arm for Square Pole
MA1051-XX=10" Arm for Square Pole20

MA1052-XX=6" Arm for Round Pole

MA1053-XX=10" Arm for Round Pole20
MA1054-XX=Wall Bracket with 6" Arm21

MA1056-XX=Direct Mount for Square Pole

MA1057-XX=Direct Mount for Round Pole

MA1201-XX=Direct Wall Mount Kit21

MA1207-XX=Mast Arm Adapter

MA1231-XX=VXM Structural Mount Wall Mount 22 Arm

MA1017-XX=Single-arm Tenon Adapter for 2 3/8" O.D. Tenon

MA1018-XX=2@180 Degree Tenon Adapter for 2 3/8" O.D. Tenon

MA1019-XX=3@120 Degree Tenon Adapter for 2 3/8" O.D. Tenon

MA1045-XX=4@90 Degree Tenon Adapter for 2 3/8 O.D. Tenon

WA1048-XX=2@90 Degree Tenon Adapter for 2 3/8"

MA1115-XX=3@90 Degree Tenon Adapter for 2 3/8' O.D. Tenon

O.D. Tenon

MA1116-XX=2@120 Degree Tenon Adapter for 2 3/8" O.D. Tenon

3/8" O.D. Tenon

MA1010-XX: Single-arm Tenon Adapter for 3 1/2"

O.D. Tenon

MA1011-XX: 2@180 Degree Tenon Adapter for 3 1/2" O.D. Tenon

MA1012-XX: 3@120 Degree Tenon Adapter for 3 1/2" O.D. Tenon

MA1013-XX: 4@90 Degree Tenon Adapter for 3 1/2" O.D. Tenon MA1014-XX: 2@90 Degree Tenon Adapter for 3 1/2"

O.D. Tenon

MA1015-XX: 2@120 Degree Tenon Adapter for 3 1/2" O.D. Tenon

MA1016-XX: 3@90 Degree Tenon Adapter for 3 1/2' O.D. Tenon

OA/RA1016= NEMA Photocontrol - Multi-Tap OA/RA1027= NEMA Photocontrol - 480V

OA/RA1201= NEMA Photocontrol - 347V

